Farmers Alliance Mutual Insurance

McPherson, Kansas

GENERAL PROJECT NOTES:

- CONTRACTOR SHALL VISIT THE SITE OF THE PROPOSED WORK AND FULLY ACQUAINT THEMSELVES WITH THE EXISTING CONDITION SO THEY MAY FULLY UNDERSTAND THE FACILITIES, RESTRICTIONS AND ANY DIFFICULTIES RELATED TO THE EXECUTION OF THE WORK.
- THE CONTRACTOR SHALL PROVIDE THE OWNER WITH A PROJECT SCHEDULE PRIOR TO COMMENCING CONSTRUCTION. THE PROJECT SCHEDULE SHALL BE MAINTAINED AND UPDATED ON A REGULAR BASIS THROUGHOUT THE CONSTRUCTION DURATION.
- THE CONTRACTOR SHALL MEET ALL CITY, COUNTY, STATE AND FEDERAL CODES AND REGULATIONS IN THE EXECUTION OF THIS PROJECT. ANY DISCREPANCIES FOUND BETWEEN DRAWINGS AND APPLICABLE CODES SHOULD BE BROUGHT TO THE IMMEDIATE ATTENTION OF THE ARCHITECT.
- ALL CONSTRUCTION MATERIALS AND ASSEMBLIES SHALL COMPLY WITH ANY AND ALL APPLICABLE CITY, COUNTY, STATE AND FEDERAL CODES AND REGULATIONS. ALL MECHANICAL, PLUMBING AND ELECTRICAL ITEMS INSTALLED, BUILDING ASSEMBLIES, AND ROOFING SYSTEMS SHALL COMPLY WITH U.L. LISTINGS REQUIRED BY THESE CODES.
- THE CONTRACTOR SHALL VERIFY ALL DIMENSIONS AND CONDITIONS OF EXISTING CONSTRUCTION. ANY DISCREPANCIES FOUND BETWEEN THESE DIMENSIONS OR CONDITIONS AND THE DRAWINGS SHALL BE BROUGHT TO THE IMMEDIATE ATTENTION OF THE ARCHITECT.
- DO NOT SCALE DRAWINGS WRITTEN DIMENSIONS TAKE PRECEDENT.
- IN CASE OF DISCREPANCIES OR CONFLICTS, NOTIFY ARCHITECT IMMEDIATELY.
- ALL WOOD IN CONTACT WITH CONCRETE AND AT EXTERIOR LOCATIONS MUST BE PRESSURE TREATED MOISTURE RESISTANT AND FIRE RETARDANT WOOD.
- ALL WALL CONSTRUCTION FACING PLUMBING FIXTURE AREA MUST UTILIZE MOISTURE RESISTANT GYPSUM BOARD UNLESS OTHERWISE NOTED.
- ALL DOORS TO BE KEYLESS IN DIRECTION OF EGRESS.

GRAPHIC SYMBOLS

KEY NOTES

REVISION & CLOUD

DEMOLITION KEY

PAINT KEY NOTE

WINDOW COVERING

- ALL MEANS OF EGRESS DOOR OPENING HARDWARE SHALL BE OPERATED BY A SINGLE HAND WITHOUT MEANS OF TIGHT GRASPING, PINCHING OR TWISTING OF THE WRIST. ALL DOORS EQUIPPED WITH PANIC HARDWARE MUST MAINTAIN A 32" CLEAR WIDTH. MAXIMUM EFFORT TO OPERATE DOORS SHALL NOT EXCEED: A. 8.5 L.B.F. (37.7N) FOR EXTERIOR DOORS.
- B. 5.0 L.B.F. (22.2N) FOR INTERIOR DOORS. • DOORS SHALL SET IN MOTION WHEN SUBJECTED TO A 30 POUND FORCE & SWING TO A FULL-OPEN POSITION WHEN SUBJECTED TO A 15 POUND FORCE. FORCES SHALL BE APPLIED TO THE LATCH SIDE.
- DOORS INDICATED AS PART OF THE REQUIRED MEANS OF EGRESS SHALL HAVE HARDWARE WHICH IS READILY OPERABLE FROM THE EGRESS SIDE WITHOUT THE USE OF A KEY, SPECIAL KNOWLEDGE OR SPECIAL EFFORT.
- PROVIDE FIRE EXTINGUISHERS AS REQUIRED PER APPLICABLE CODES AND COORDINATE EXACT LOCATION WITH FIRE MARSHAL

- PROVIDE AND INSTALL OCCUPANCY SIGN IN A CONSPICUOUS LOCATION IN ACCORDANCE WITH STATE & LOCAL CODES.
- ALL LIGHT SWITCHES, THERMOSTATS, SECURITY ALARMS, ELECTRICAL OUTLETS, ETC. MUST BE MOUNTED TO MEET ALL GOVERNING ACCESSIBILITY REQUIREMENTS FOR FLOOR & HEIGHT CLEARANCES AND ONE HAND GRASPING OPERATION.
- CONTROLS SUCH AS LIGHT SWITCHES, HEATING/AIR CONDITIONING CONTROLS, FIRE ALARM PULLS AND ELECTRICAL OUTLETS ARE WITHIN SPECIFIED REACH RANGES AND HAVE ADEQUATE CLEAR FLOOR SPACE FOR ACCESS. OPERABLE PARTS MUST BE OPERABLE WITH ONE HAND AND NOT REQUIRE TIGHT PINCHING OR GRASPING.
- ALL INTERIOR DIMENSIONS ARE FACE OF STUD TO FACE OF STUD. UNLESS NOTED
- REINFORCING STEEL OR STRUCTURAL FRAMEWORK OF ANY PART OF ANY BUILDING OR STRUCTURE SHALL NOT BE COVERED OR CONCEALED WITHOUT RECEIVING INSPECTION APPROVAL BY THE BUILDING DEPARTMENT. IN ADDITION TO REQUIRED ELECTRICAL, MECHANICAL AND PLUMBING INSPECTIONS, THE BUILDING PERMIT HOLDER OR HIS AGENT SHALL REQUEST THE BUILDING DEPARTMENT TO MAKE THE FOLLOWING CALLED BUILDING CONSTRUCTION INSPECTIONS:
- a. FOUNDATION INSPECTION PRIOR TO THE POURING OF CONCRETE.
- b. FRAME INSPECTION AFTER PIPES, CHIMNEYS AND VENTS ARE INSTALLED BUT PRIOR TO CONCEALING THE FRAMEWORK.
- c. INSULATION AND WALL BOARD INSPECTION.
- d. FINAL INSPECTION PRIOR TO OCCUPANCY OF THE BUILDING.
- A SET OF BUILDING PLANS AND SPECIFICATIONS APPROVED BY THE BUILDING DEPARTMENT AND MARKED "FIELD COPY" SHALL BE KEPT ON THE PROJECT DURING CONSTRUCTION UNTIL FINAL INSPECTION APPROVAL HAS BEEN MADE.
- CHANGES MADE DURING CONSTRUCTION OF A PROJECT, THAT AFFECT EXITING, WALL CONFIGURATION AND STRUCTURAL ELEMENTS THAT ARE NOT JUST "COSMETIC" REQUIRE REVISED PLANS TO BE SUBMITTED TO THE BUILDING DEPARTMENT FOR REVIEW AND APPROVAL. IF A LICENSED ARCHITECT OR ENGINEER SEALED THE ORIGINAL PLANS, THE REVISED PLANS MUST ALSO BE SEALED.
- GENERAL CONTRACTOR SHALL BE RESPONSIBLE TO PROVIDE A WEATHER TIGHT SEAL FOR ALL PENETRATIONS ABOVE AND BELOW GROUND INTO BUILDING.
- DESIGN PROFESSIONALS ASSOCIATED WITH THIS PROJECT ARE NOT RESPONSIBLE FOR METHODS OF CONSTRUCTION, WORK SAFETY AND THE CONTRACTOR'S COMPLIANCE WITH CITY, COUNTY, STATE AND FEDERAL CODES AND REGULATIONS PERTAINING TO METHODS OF CONSTRUCTION AND WORK SAFETY.
- THIS SET OF DRAWINGS IS FOR A PORTION OF THE BUILDING BEING REMODELED. AREA OF WORK WILL BE DESIGNED TO MEET THE CURRENT ADOPTED BUILDING CODES. IN ADDITION WILL BE SEPARATED FROM THE REST OF THE BUILDING WITH SMOKE BARRIER AND MAINTAINED FOR THE DURATION OF THE CONSTRUCTION. THE AREA OF THE BUILDING OUTSIDE OF THIS AREA OF WORK WILL REMAIN UNTOUCHED. NO PHASING WILL BE REQUIRED.

ABBREVIATIONS:

DETAIL MARK C1 DETAIL NU A404 SHEET NU		AL B-# BS-# C-# CN	ALUMINUM WALL BASE FINISH BARSTOOL, REF. FURNITURE SCHEDULE CEILING FINISH CONCRETE
EXTERIOR A1 DETAIL NU	JMBER	CJ	CONTROL JOINT
EXTERIOR — ···		CP	CARPET TILE
ELEVATION A200 SHEET NU	JIVIDER	CH	COAT HOOK
A1-		CH-#	CHAIR, REF. FURNITURE SCHEDULE
DETAIL NU	JMBER	CT	CERAMIC TILE
WITTENIAR \		DW	DISHWASHER
INTERIOR A4 A500 A2		ES	EXPOSED STRUCTURE
ELEVATION SHEET NU	IMRED	EX	EXISTING
	MIDER	F-#	FLOORING FINISH
A3		FEC	FIRE EXTINGUISHER AND CABINET
		FE	FIRE EXTINGUISHER AND WALL BRACKET
BUILDING A1 DETA	AIL NUMBER	FF	FACTORY FINISH
29,22,110	ET NUMBER	GB	GYPSUM BOARD
SECTION 330	21 NOMBER	GL	GLASS
^		HM	HOLLOW METAL
I 2000		L-#	SOFA, REF. FURNITURE SCHEDULE
VV/\LL	AIL NUMBER	MB	MARKER BOARD
SECTION 350 /- SHEE	ET NUMBER	FV	FIELD VERIFY ACTUAL CONDITIONS
			FACE OF WALL
HEIGHT ELEVATION 1ST FLOOR -	-ELEVATION ITEM		FACE OF OPENING
DATUM MART FL. = 100'-0"	-ELEVATION	MP	METAL PANEL
7 EE 100-0	FELEVATION	MW	MICROWAVE
N I A B 4 🚾		NF	NO FINISH
ROOM NAME AND NAME	-ROOM NAME		OCCASIONAL TABLE, REF. FURNITURE SCHEDULE
147 (141)		P-#	POUF, REF. FURNITURE SCHEDULE
NUMBER 000 +	-ROOM NUMBER	PW	PLYWOOD
		R-#	FLOOR RUG, REF. FURNITURE SCHEDULE
DOOR MARK (101/01) →	-DOOR NUMBER, REF.	SC	CONCRETE W/ SEALER (SEALED CONCRETE)
(01/0)	DOOR SCHEDULE	ST-#	STAIN FINISH
		PL-#	PLASTIC LAMINATE FINISH
DOOR TYPE MARK A	-REF. WINDOW TYPES	PT-#	PAINT (1 PRIME COAT, 2 FINISH COATS)
		PU-#	CABINET HARDWARE - PULLS COUNTER TOP FINISH - QUARTZ
		Q-# T-#	TABLE - REF. FURNITURE SCHEDULE
WALL TYPE MARK (A1)	-REF. WALL TYPE	TO	TAPE ONLY
V	SCHEDULE	TV	WALL MOUNTED TV (PROVIDED BY OWNER)
VEV NOTES	-REF. KEY NOTE LEGEND	VT	VINYL TILE
KEY NOTES 1	ON EACH SHEET	V I W-#	WALL FINISH / PANEL
_	ON LAGIT STILLT	WM	WALK OFF MAT
		V V I V I	YVALIX OF FIVEAU

REF. DEMOLITION KEY NOTE

-REF. WINDOW COVERING

SCHEDULE

-REF. FINISH PLAN

- REVISION KEYNOTE

PROJECT CONSTRUCTION SAFETY

- 2018 IFC CHAPTER 33: NO SMOKING SHALL BE ALLOWED IN THE BUILDING. ALL CONSTRUCTION DEBRIS AND TRASH SHALL BE REMOVED EACH DAY IN AN APPROVED CONTAINER OUTSIDE THE BUILDING.
- ALL NEW CONSTRUCTION WILL BE SEPARATED AND MAINTAINED FROM REST OF EXISTING BUILDING.
- ALL OPENINGS THRU RATED WALL SHALL REQUIRE FIRE RATING, REF. DOOR SCHEDULE.
- EXISTING EGRESS WILL BE MAINTAINED DURING CONSTRUCTION. PORTABLE FIRE EXTINGUISHERS SHALL BE PROVIDED THROUGHOUT THE NEW
- CONSTRUCTION AREA FOR THE DURATION OF THE PROJECT. • PRIOR TO REMOVAL OF TEMPORARY SEPARATION WALL. COMPLETION OF WORK WILL NEED APPROVAL BY AUTHORITY HAVING JURISDICTION (AHJ). ONCE APPROVED, REMOVAL OF TEMPORARY WALL AND FINAL WORK CAN BE

DRAWING INDEX:

GENERAL	
G000	COVER SHEET
G001	ADA ACCESSIBILITY
CC100	CODE COMPLIANCE
CC101	CODE COMPLIANCE

ARCHITECTURAL

AD102	LEVEL 2 DEMO PLAN
A010	FINISH PLAN & SCHEDULE
A020	DOOR SCHEDULE
A102	LEVEL 2 FLOOR PLAN
A152	LEVEL 2 REFLECTED CEILING PLAN
A250	BUILDING SECTIONS
A400	ENLARGED PLANS
A500	INTERIOR ELEVATIONS
A501	INTERIOR ELEVATIONS
A550	INTERIOR SECTIONS
A551	INTERIOR SECTIONS
A600	FURNITURE PLAN & SCHEDULE

KITCHEN FOUIPMENT

INTOTIENT	Lagon ment
K-100	FOOD SERVICE EQUIPMENT PLAN
K-200	FOOD SERVICE ELECTRICAL ROUGH-IN
K-300	FOOD SERVICE PLUMBING ROUGH-IN

MECHANICAL / PLUMBING

MP001	MECHANICAL DESIGN CRITERIA
MP101	MECHANICAL SCHEDULES
MP201	MECHANICAL DETAILS
PD101	PLUMBING DEMO PLAN
P101	PLUMBING PLAN
MD101	HVAC DEMO PLAN
M101	HVAC PLAN

ELECTRICAL


<u>EL</u>	LECTRICAL	
E1	01	ELECTRICAL SCHEDULES
E2	201	ELECTRICAL FLOOR PLAN - POWER
E2	202	ENLARGED ELECTRICAL POWER PLAN
E2	203	ELECTRICAL FLOOR PLAN - HVAC EQUIP. CONNECTION
E3	801	ELECTRICAL FLOOR PLAN - LIGHTING
E4	-01	ELECTRICAL SPECFIFICATIONS


Contract Date Rev No. 2 Rev No. 3 Rev No. 4 Rev No. 5 Rev No. 6 Project Number: G000.dwg DWG File Designed By: Drawn By: Approved By: plan4 03.25.24 Date:





SHEET NUMBER

11 x 17 = 1/2 scale

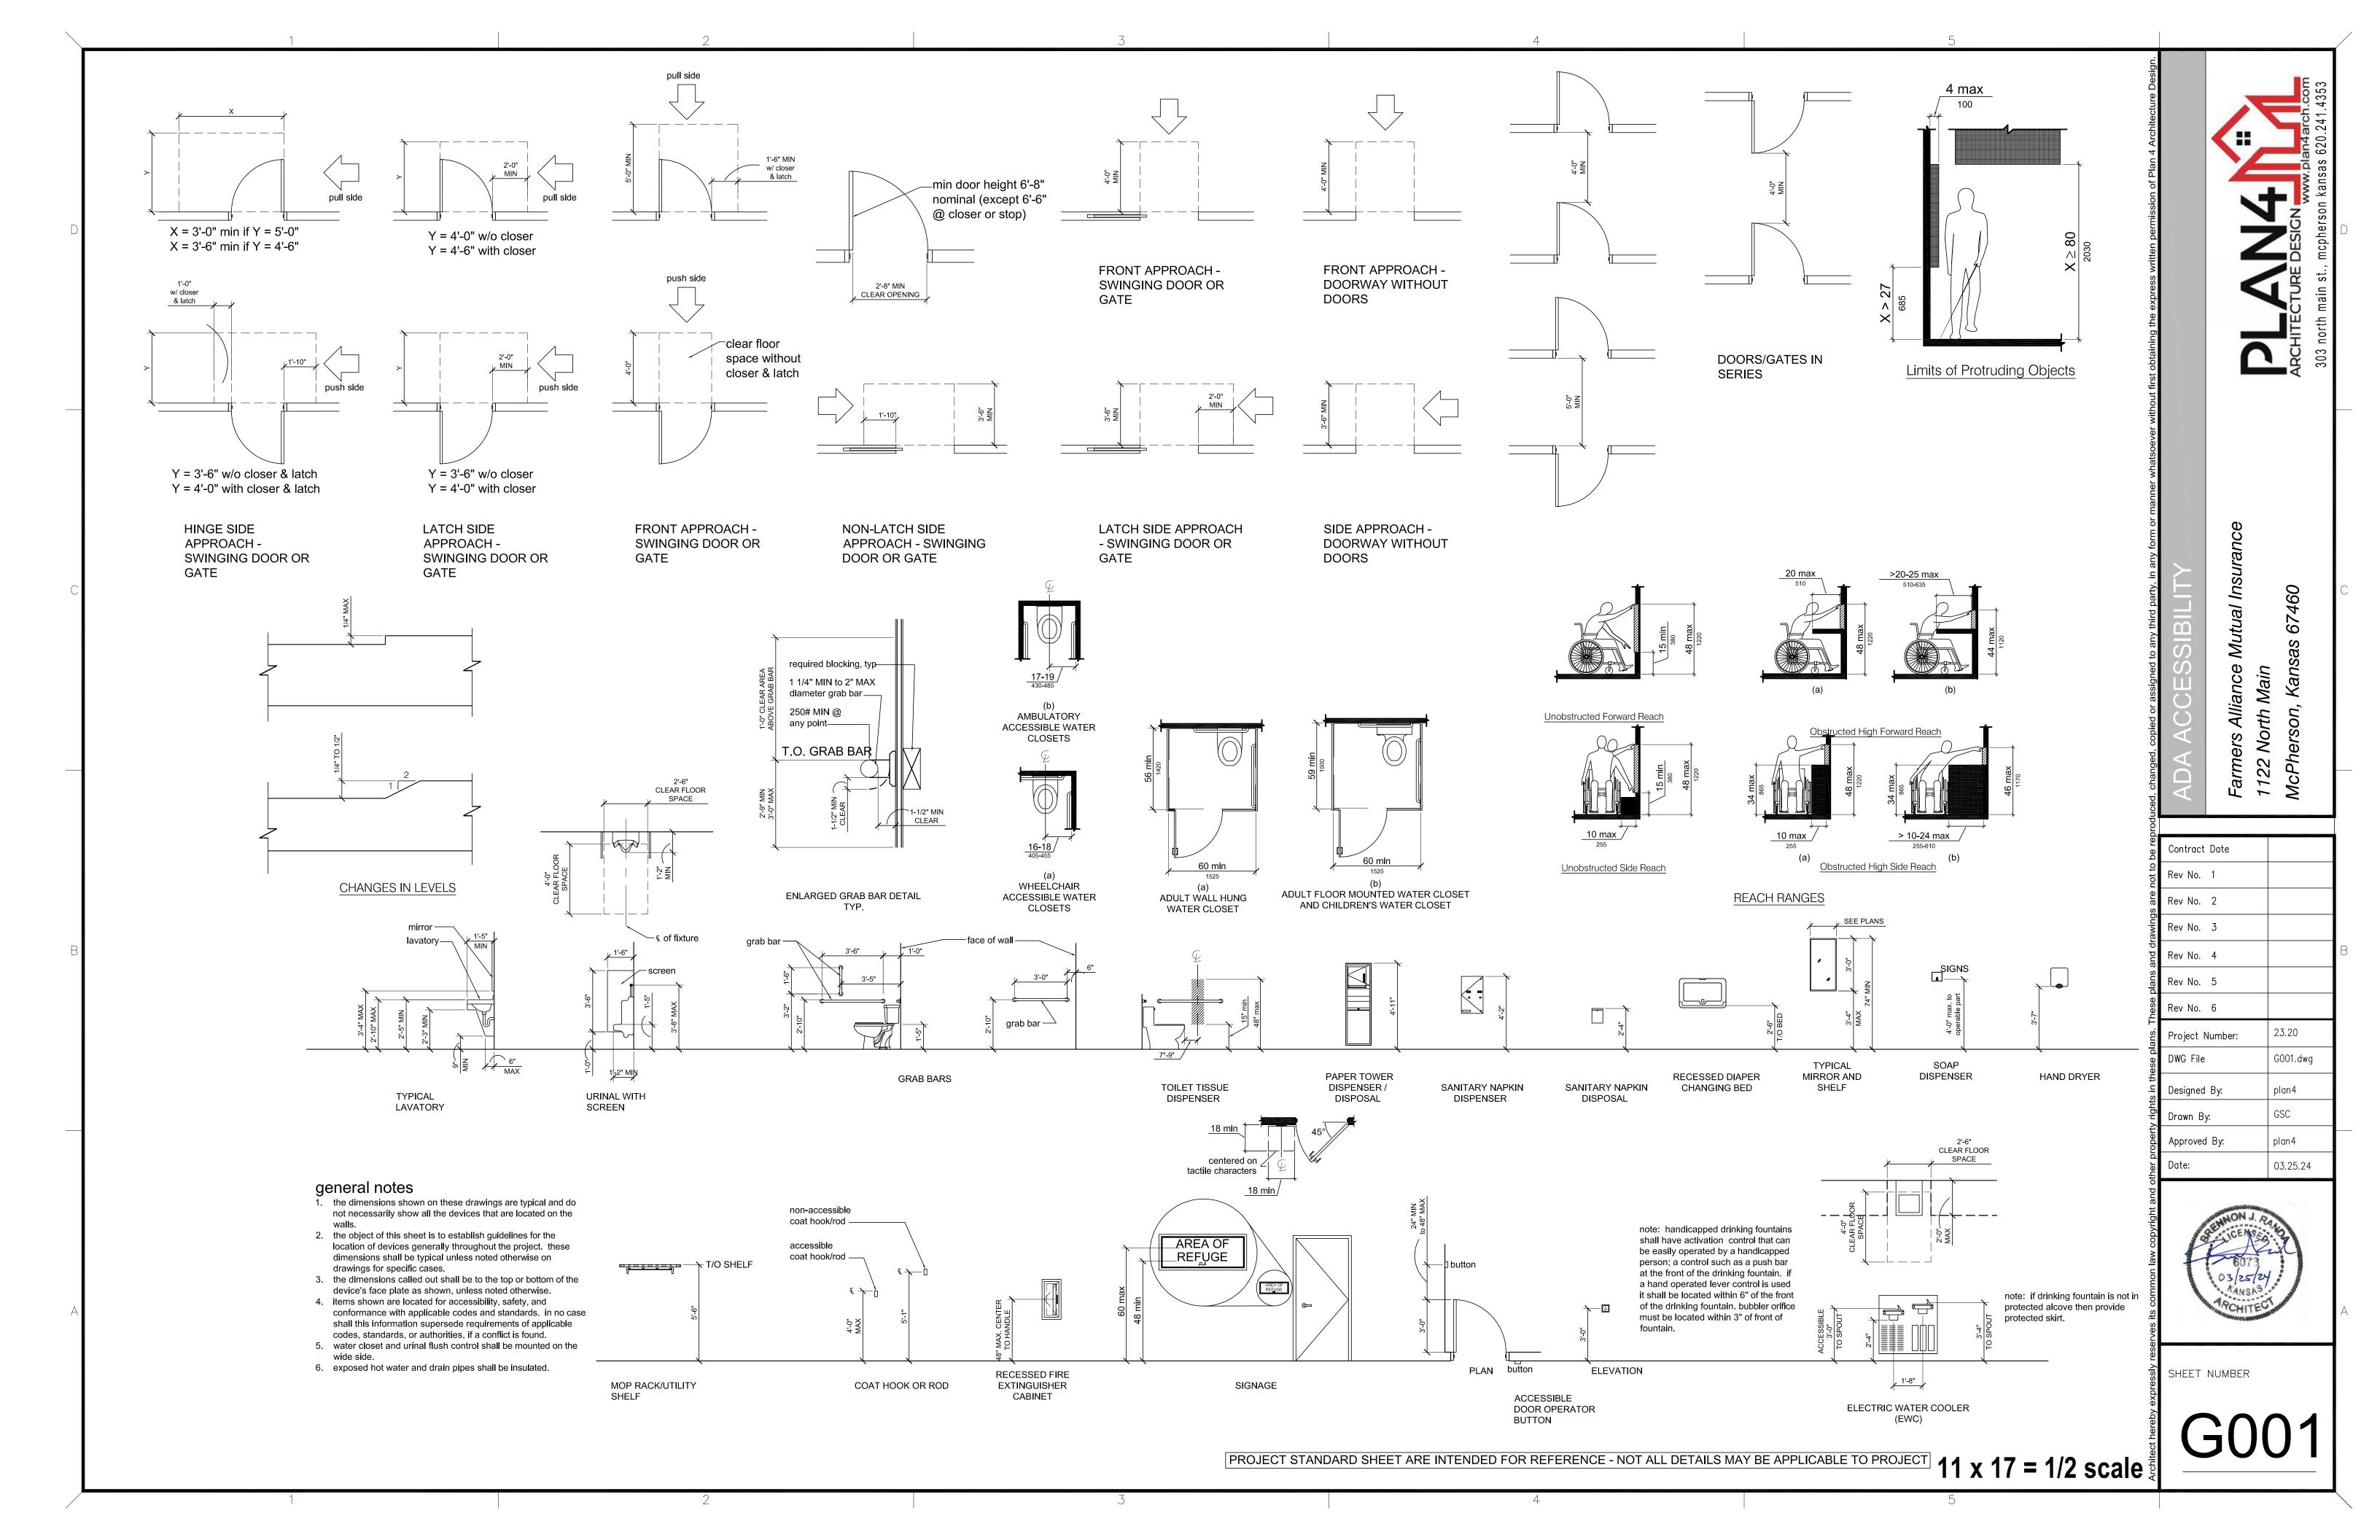


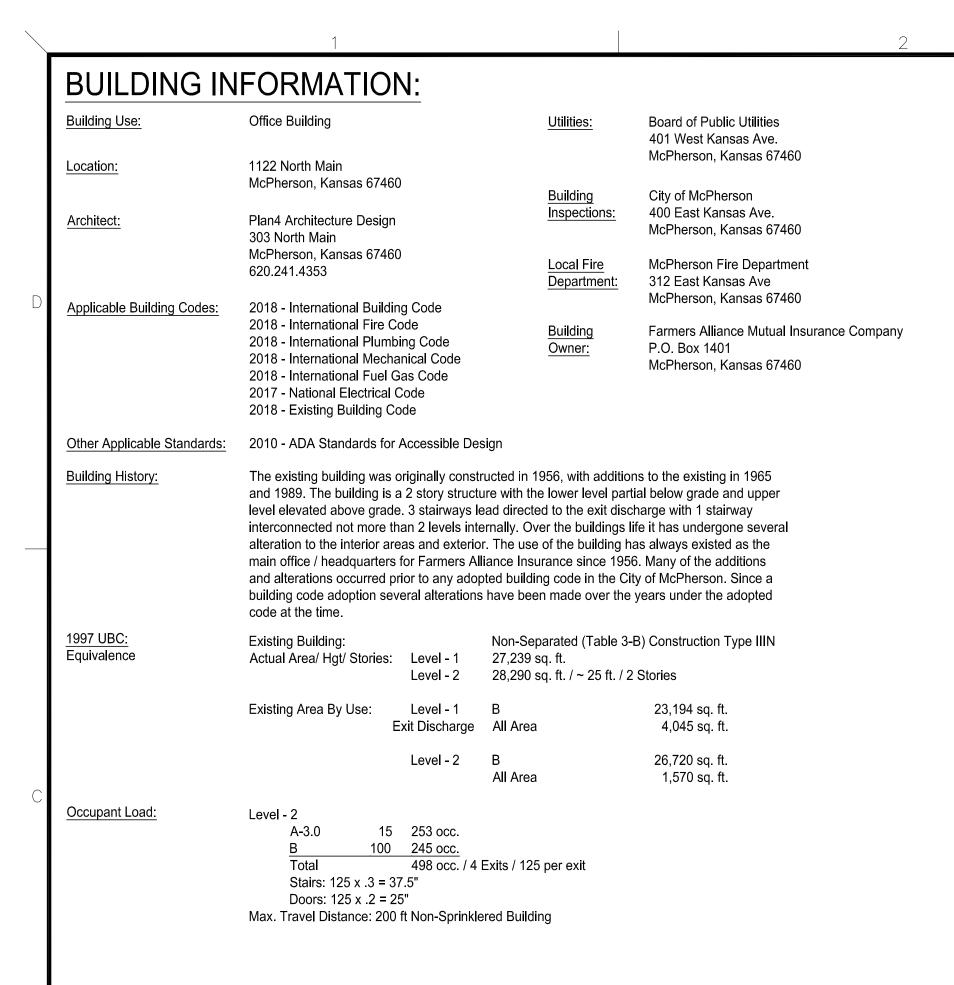

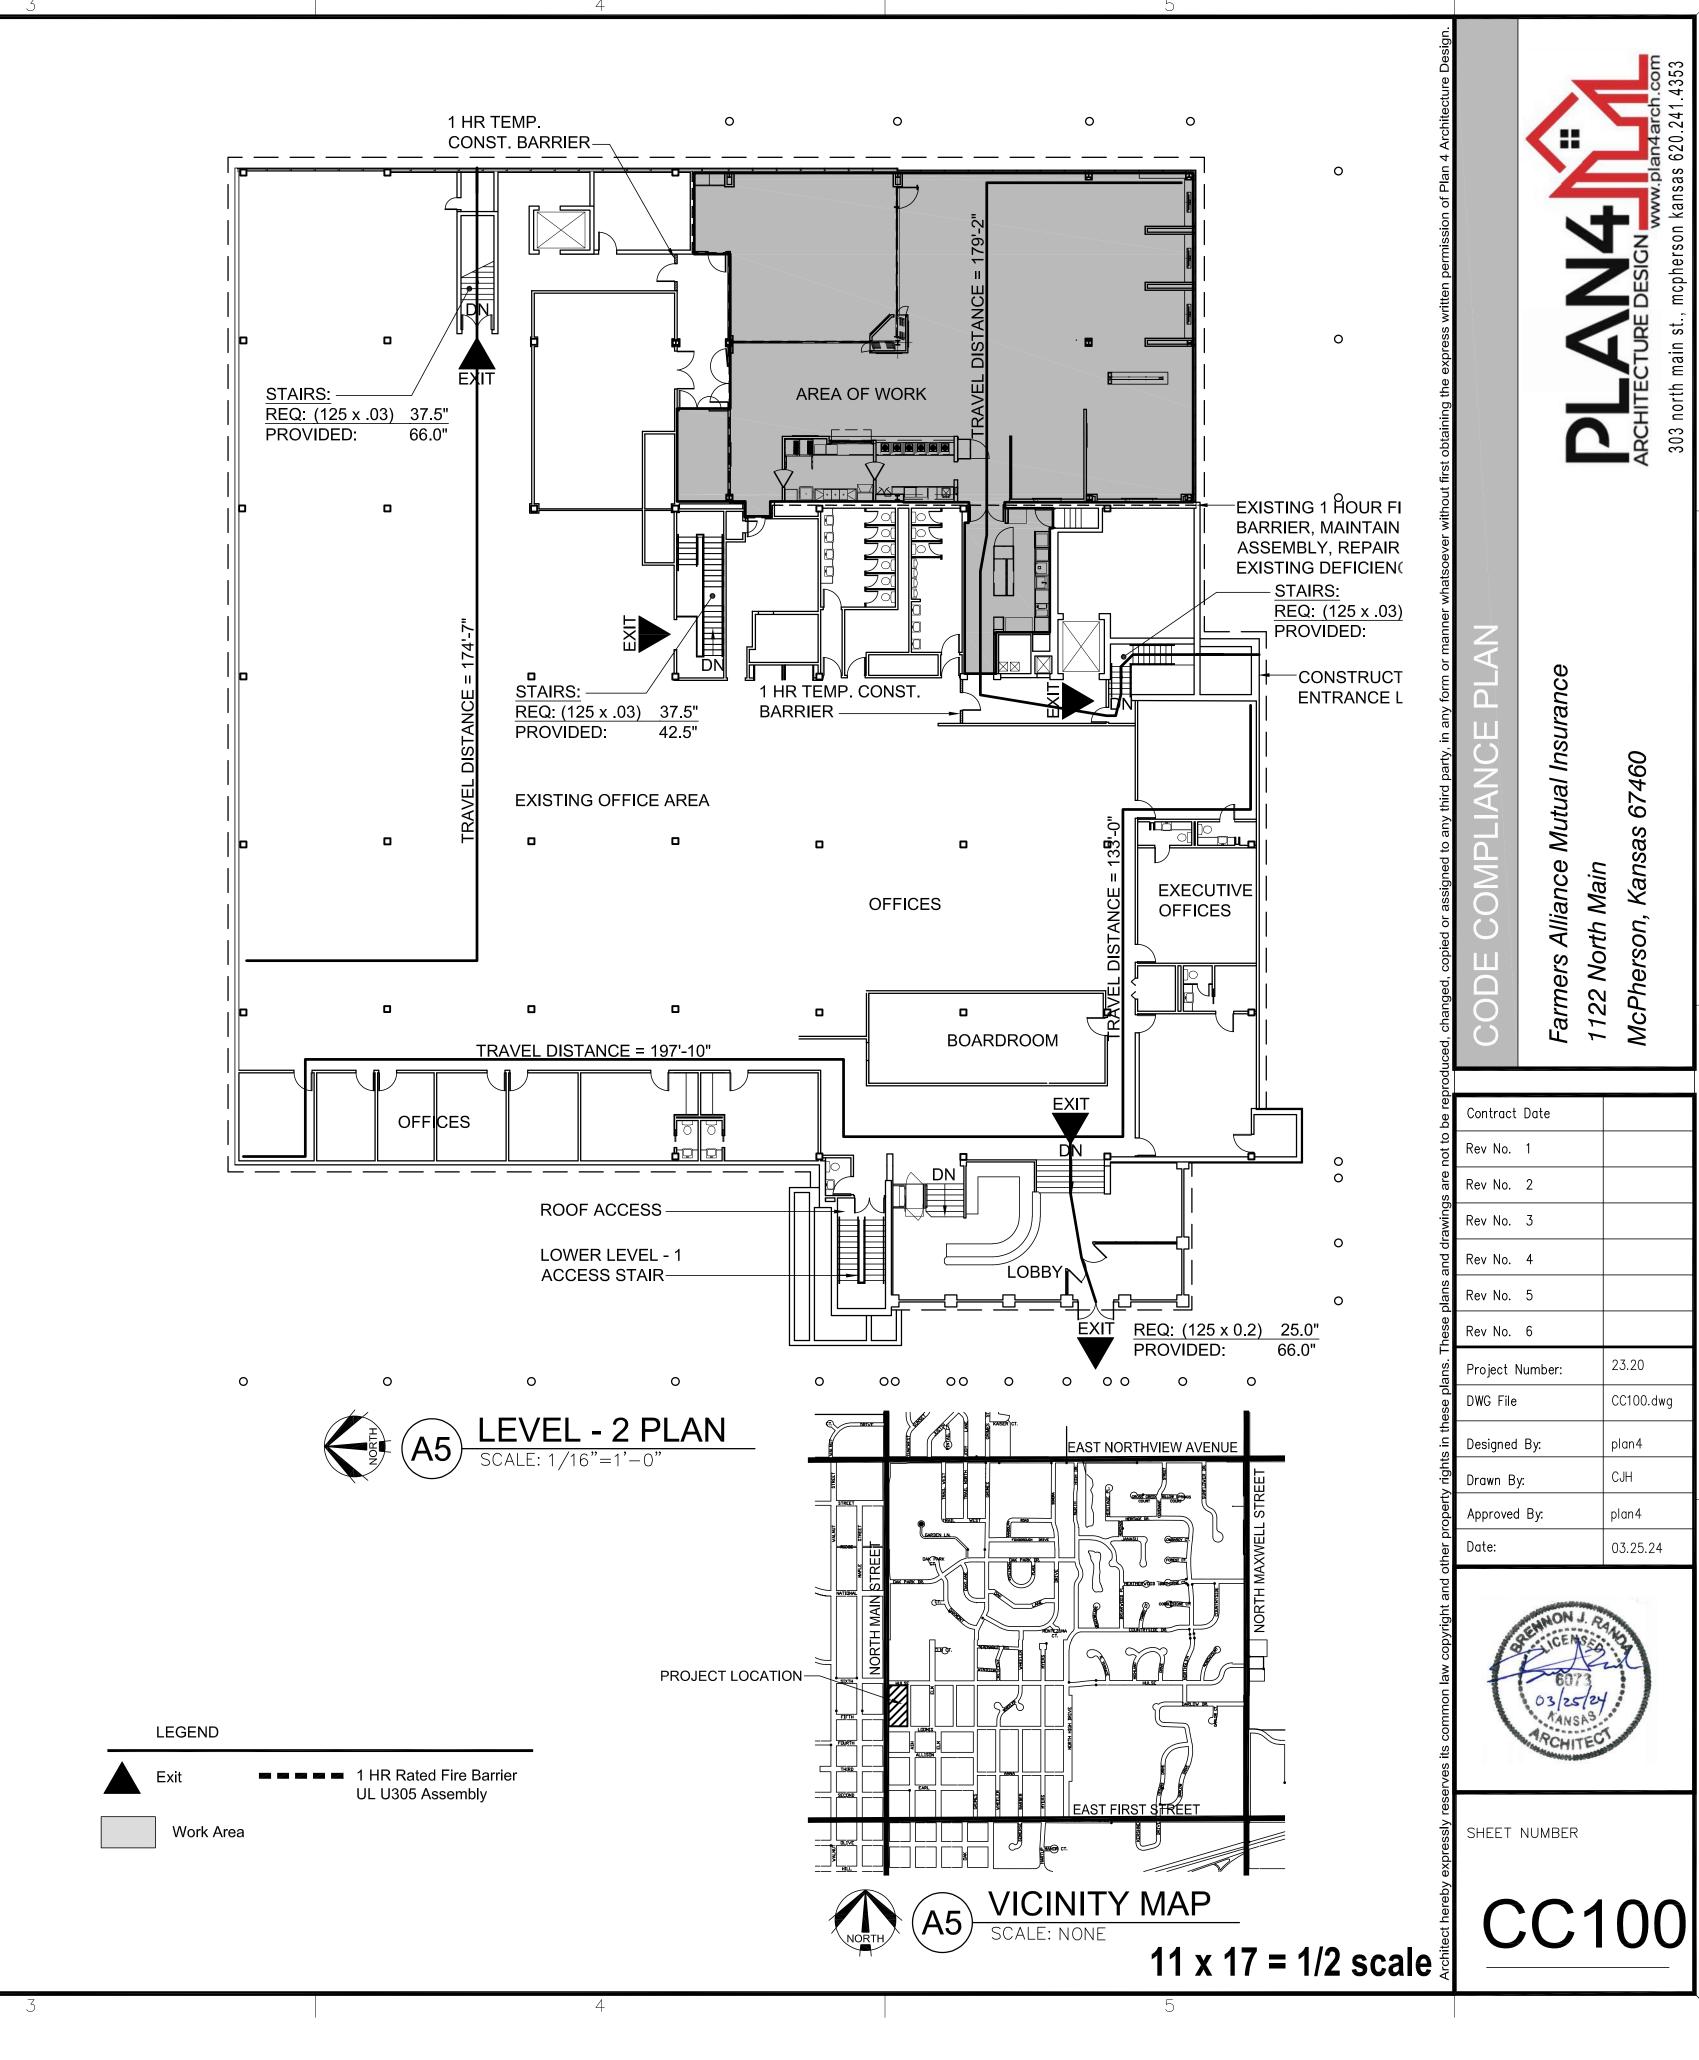

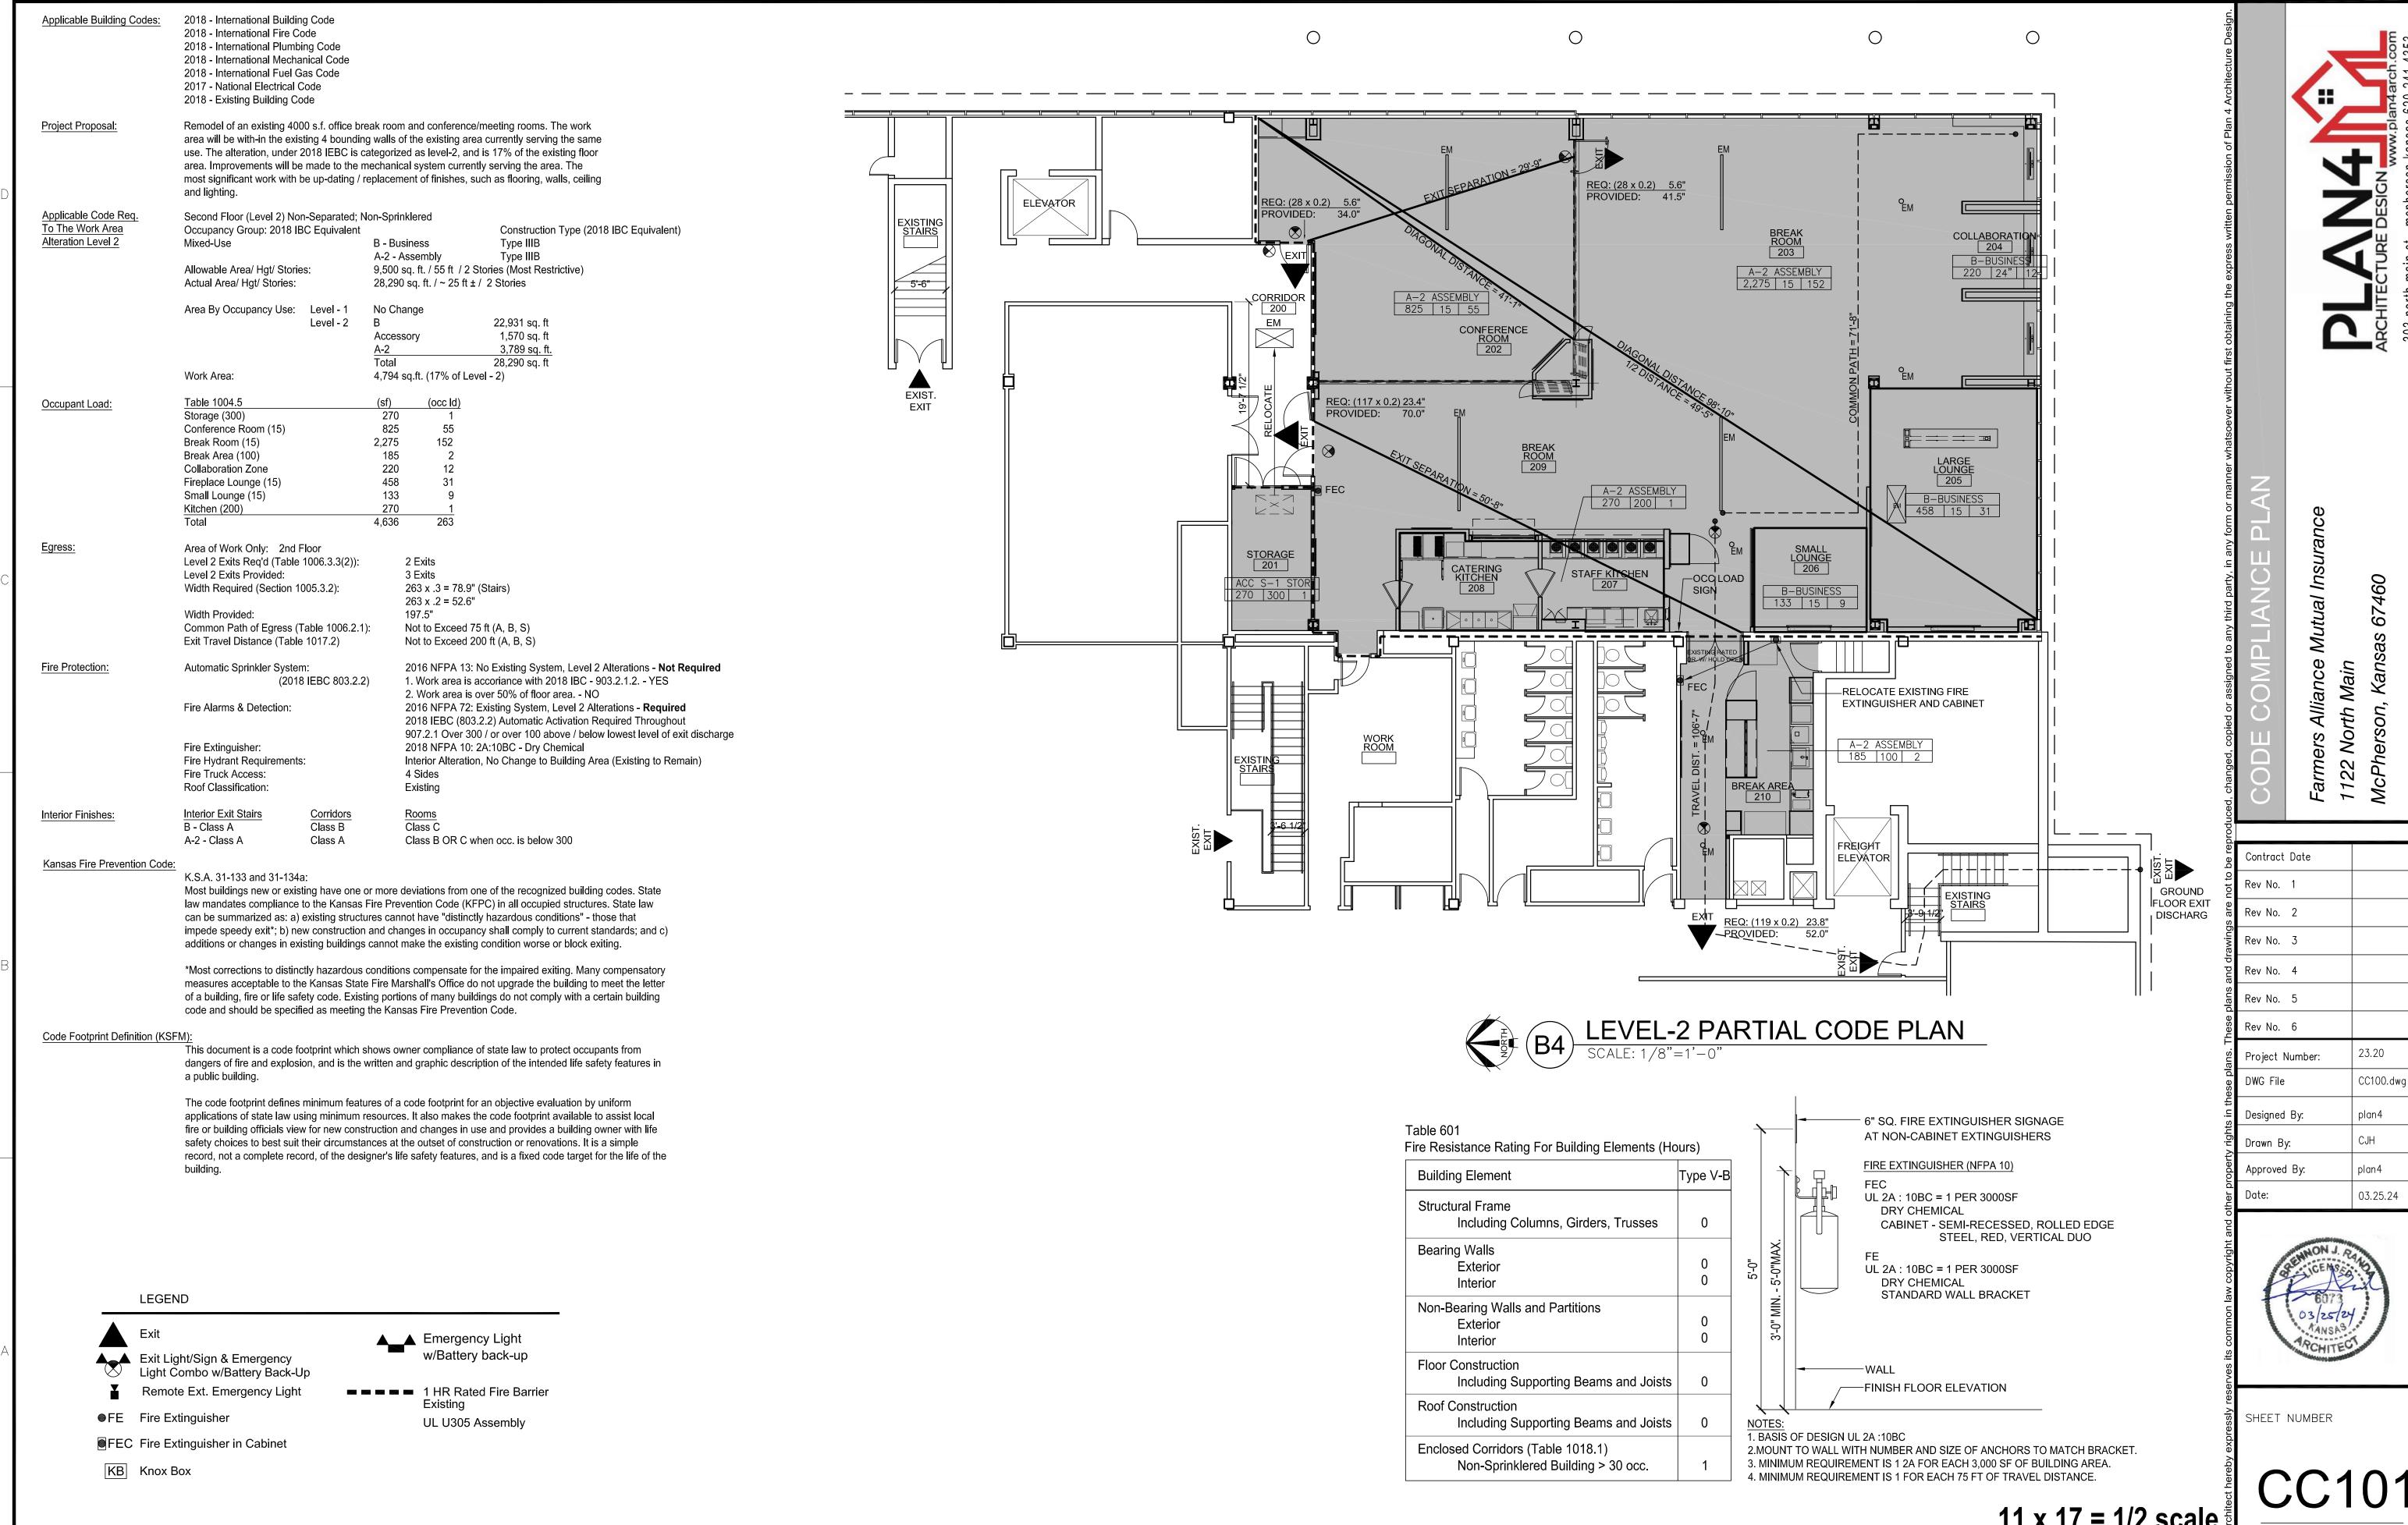

11 x 17 = 1/2 scale ₹

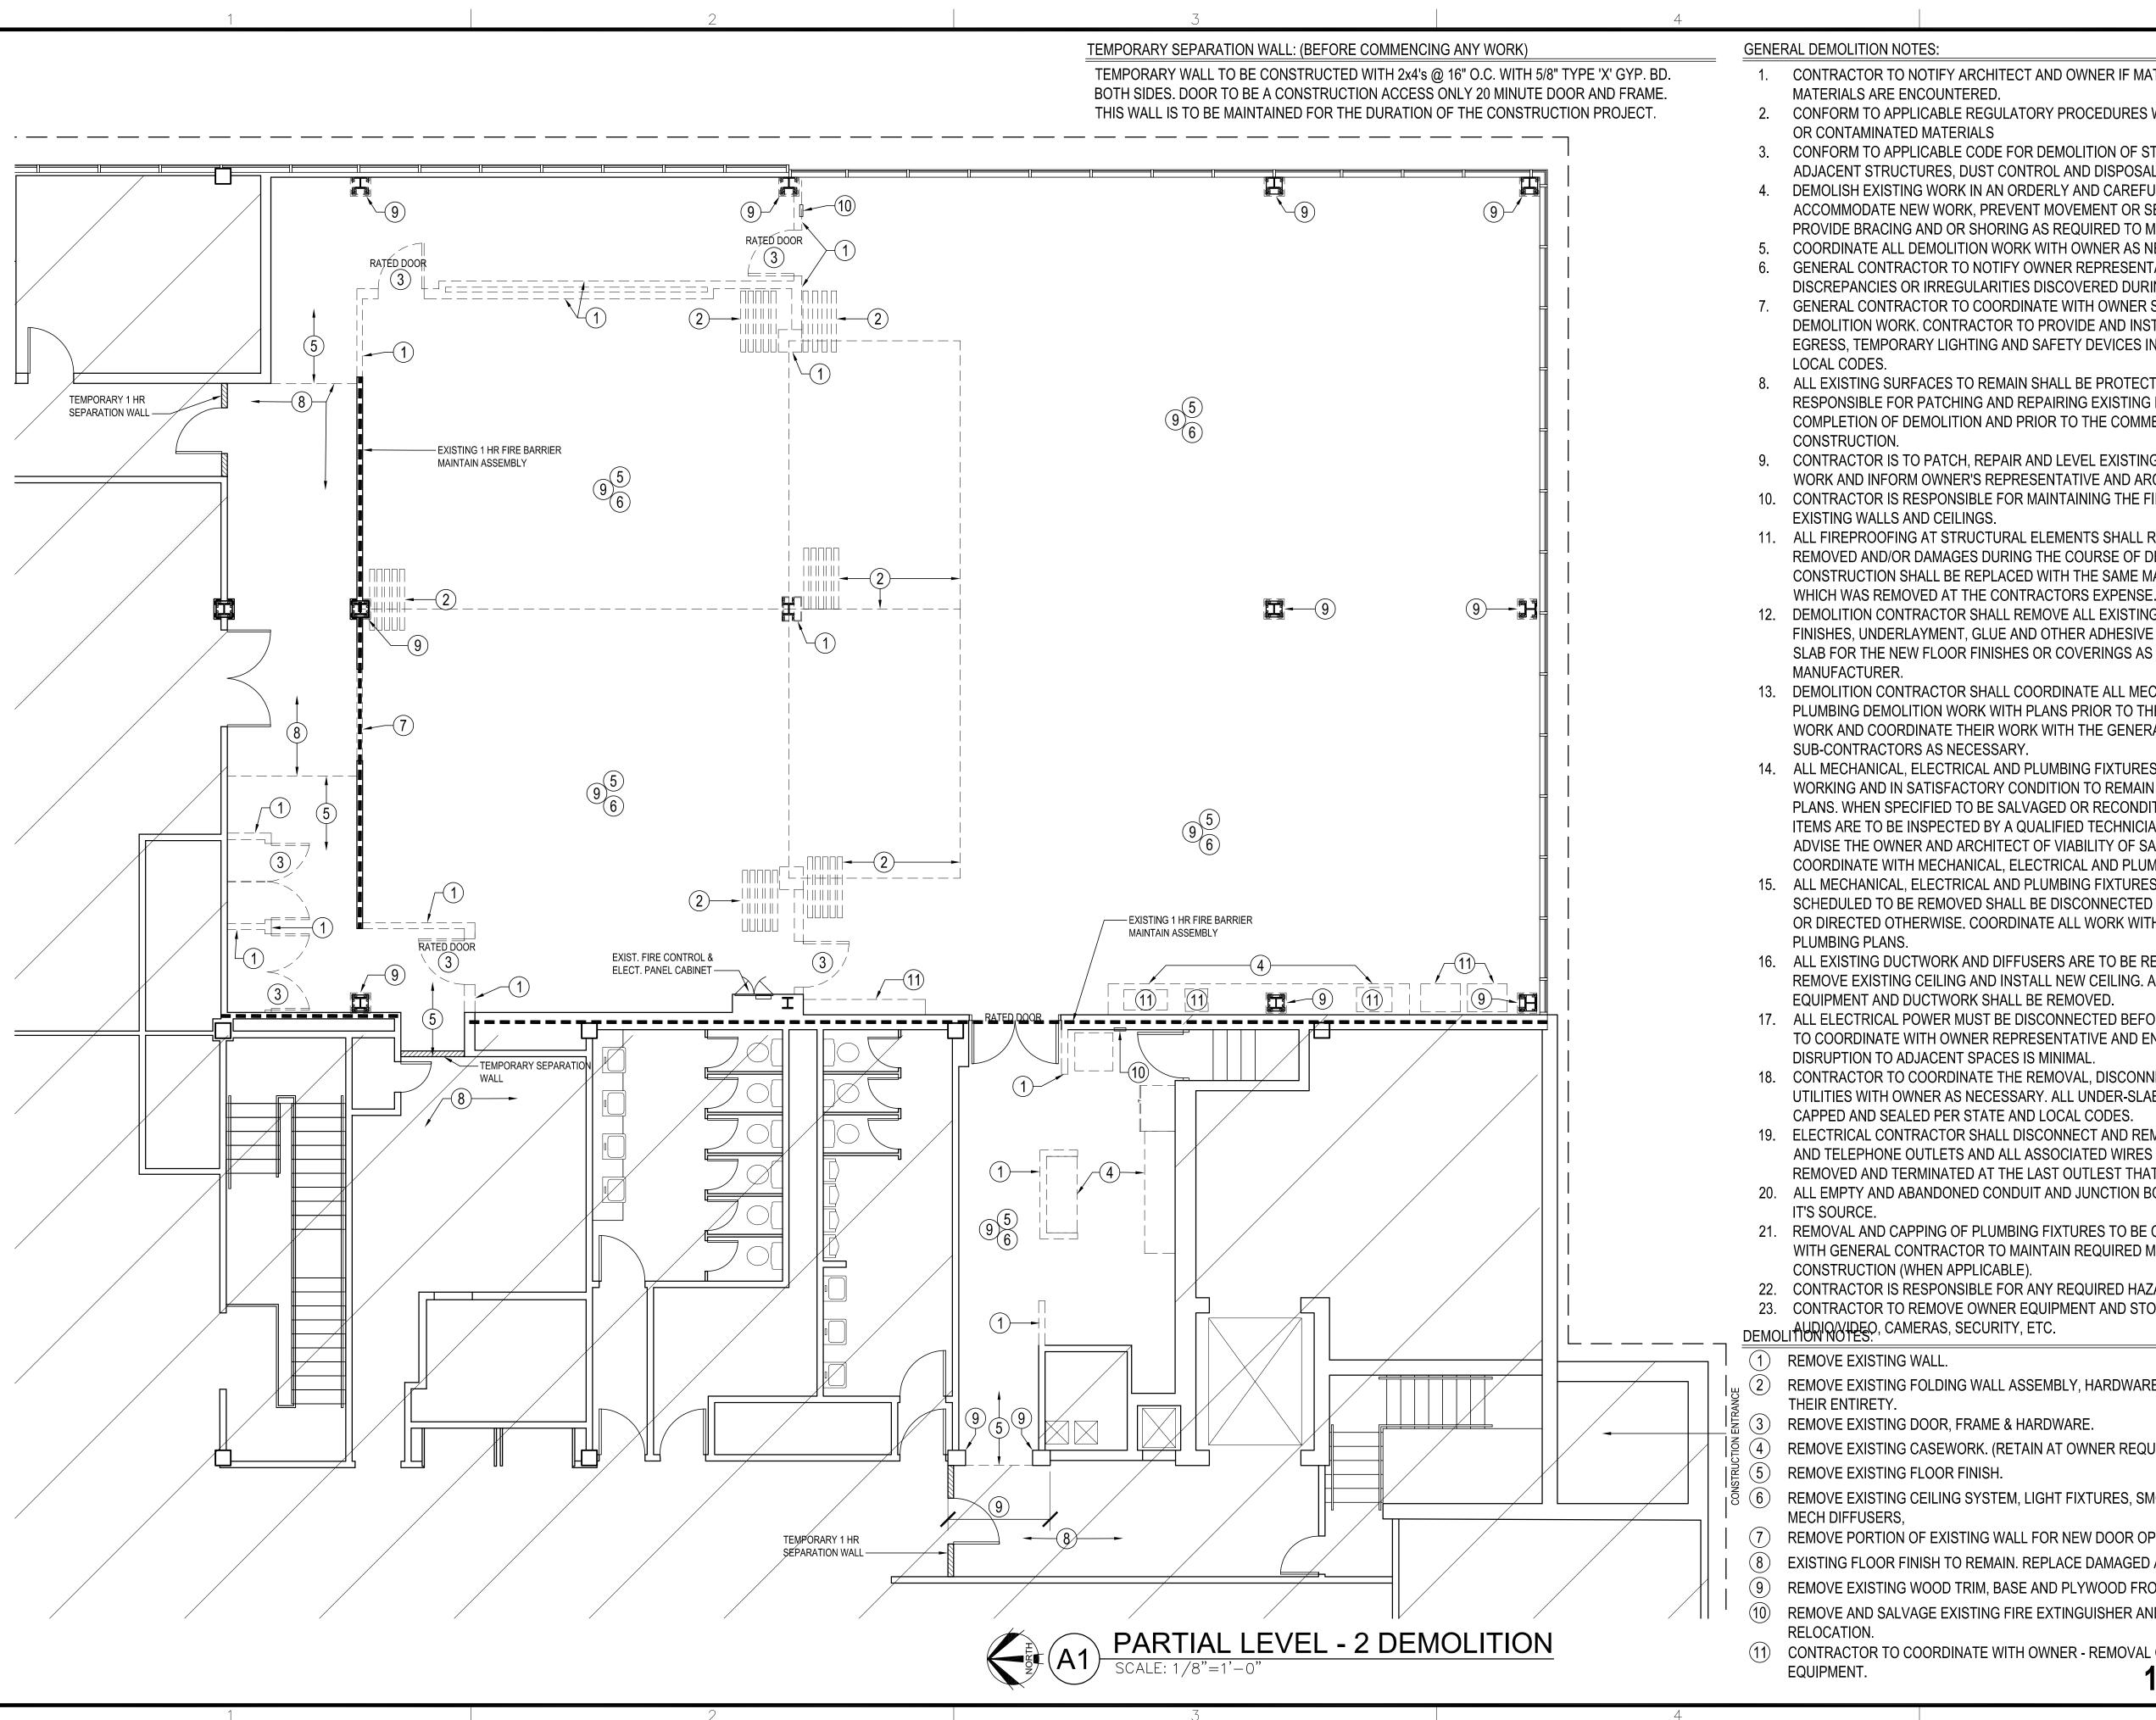

GENERAL DEMOLITION NOTES:

- CONTRACTOR TO NOTIFY ARCHITECT AND OWNER IF MATERIALS CONTAINING HAZARDOUS MATERIALS ARE ENCOUNTERED.
- 2. CONFORM TO APPLICABLE REGULATORY PROCEDURES WHEN DISCOVERING HAZARDOUS OR CONTAMINATED MATERIALS
- CONFORM TO APPLICABLE CODE FOR DEMOLITION OF STRUCTURES, SAFETY OF ADJACENT STRUCTURES, DUST CONTROL AND DISPOSAL OF MATERIALS.
- DEMOLISH EXISTING WORK IN AN ORDERLY AND CAREFUL MANNER AS REQUIRED TO ACCOMMODATE NEW WORK, PREVENT MOVEMENT OR SETTLEMENT OF STRUCTURE. PROVIDE BRACING AND OR SHORING AS REQUIRED TO MAINTAIN SAFETY.
- COORDINATE ALL DEMOLITION WORK WITH OWNER AS NECESSARY.
- GENERAL CONTRACTOR TO NOTIFY OWNER REPRESENTATIVE AND ARCHITECT OF ANY DISCREPANCIES OR IRREGULARITIES DISCOVERED DURING CONSTRUCTION
- GENERAL CONTRACTOR TO COORDINATE WITH OWNER SCHEDULE AND TIMING OF DEMOLITION WORK. CONTRACTOR TO PROVIDE AND INSTALL ALL TEMPORARY MEANS OF EGRESS, TEMPORARY LIGHTING AND SAFETY DEVICES IN ACCORDANCE WITH STATE AND LOCAL CODES.
- ALL EXISTING SURFACES TO REMAIN SHALL BE PROTECTED. CONTRACTOR IS RESPONSIBLE FOR PATCHING AND REPAIRING EXISTING FLOOR SLABS AND WALLS AFTER COMPLETION OF DEMOLITION AND PRIOR TO THE COMMENCEMENT OF NEW CONSTRUCTION.
- CONTRACTOR IS TO PATCH, REPAIR AND LEVEL EXISTING FLOOR SLAB TO RECEIVE NEW WORK AND INFORM OWNER'S REPRESENTATIVE AND ARCHITECT OF ANY IRREGULARITIES.
- 10. CONTRACTOR IS RESPONSIBLE FOR MAINTAINING THE FIRE RATING AND INTEGRITY OF EXISTING WALLS AND CEILINGS.
- 11. ALL FIREPROOFING AT STRUCTURAL ELEMENTS SHALL REMAIN U.N.O. ANY FIREPROOFING REMOVED AND/OR DAMAGES DURING THE COURSE OF DEMOLITION AND SUBSEQUENT CONSTRUCTION SHALL BE REPLACED WITH THE SAME MATERIALS AND RATINGS AS THAT
- 12. DEMOLITION CONTRACTOR SHALL REMOVE ALL EXISTING FLOOR COVERING AND/OR FINISHES, UNDERLAYMENT, GLUE AND OTHER ADHESIVE AND SHALL PREPARE THE FLOOR SLAB FOR THE NEW FLOOR FINISHES OR COVERINGS AS SPECIFIED BY THE MANUFACTURER.
- 13. DEMOLITION CONTRACTOR SHALL COORDINATE ALL MECHANICAL, ELECTRICAL AND PLUMBING DEMOLITION WORK WITH PLANS PRIOR TO THE COMMENCEMENT OF ANY WORK AND COORDINATE THEIR WORK WITH THE GENERAL CONTRACTOR AND OTHER SUB-CONTRACTORS AS NECESSARY.
- 14. ALL MECHANICAL, ELECTRICAL AND PLUMBING FIXTURES, EQUIPMENT AND/OR DEVICES IN WORKING AND IN SATISFACTORY CONDITION TO REMAIN AND RE-USED AS NOTED PER PLANS. WHEN SPECIFIED TO BE SALVAGED OR RECONDITIONED FOR RE-USE, THESE ITEMS ARE TO BE INSPECTED BY A QUALIFIED TECHNICIAN OR TRADESPERSON AND SHALL ADVISE THE OWNER AND ARCHITECT OF VIABILITY OF SALVAGED ITEMS FOR RE-USE. COORDINATE WITH MECHANICAL. ELECTRICAL AND PLUMBING PLANS.
- 15. ALL MECHANICAL, ELECTRICAL AND PLUMBING FIXTURES, EQUIPMENT AND/OR DEVICES SCHEDULED TO BE REMOVED SHALL BE DISCONNECTED AT THE SOURCE UNLESS NOTED OR DIRECTED OTHERWISE. COORDINATE ALL WORK WITH MECHANICAL ELECTRICAL AND PLUMBING PLANS.
- 16. ALL EXISTING DUCTWORK AND DIFFUSERS ARE TO BE REMOVED TO EXTENT REQUIRED TO REMOVE EXISTING CEILING AND INSTALL NEW CEILING. ALL ABANDONED HVAC EQUIPMENT AND DUCTWORK SHALL BE REMOVED.
- 17. ALL ELECTRICAL POWER MUST BE DISCONNECTED BEFORE STARTING DEMOLITION. G.C. TO COORDINATE WITH OWNER REPRESENTATIVE AND ENSURE THAT ELECTRICAL DISRUPTION TO ADJACENT SPACES IS MINIMAL
- 18. CONTRACTOR TO COORDINATE THE REMOVAL, DISCONNECTION AND/OR CAPPING OF ANY UTILITIES WITH OWNER AS NECESSARY. ALL UNDER-SLAB UTILITIES LINES TO BE CUT, CAPPED AND SEALED PER STATE AND LOCAL CODES.
- 19. ELECTRICAL CONTRACTOR SHALL DISCONNECT AND REMOVE ALL EXISTING ELECTRICAL AND TELEPHONE OUTLETS AND ALL ASSOCIATED WIRES IN WALLS SCHEDULE TO BE REMOVED AND TERMINATED AT THE LAST OUTLEST THAT REMAINS IN SERVICE.
- 20. ALL EMPTY AND ABANDONED CONDUIT AND JUNCTION BOXES TO BE REMOVED BACK TO IT'S SOURCE.
- 21. REMOVAL AND CAPPING OF PLUMBING FIXTURES TO BE COORDINATED PER PLAN AND WITH GENERAL CONTRACTOR TO MAINTAIN REQUIRED MINIMUM USAGE DURING CONSTRUCTION (WHEN APPLICABLE).
- CONTRACTOR IS RESPONSIBLE FOR ANY REQUIRED HAZARDOUS MATERIAL TESTING. 23. CONTRACTOR TO REMOVE OWNER EQUIPMENT AND STORE AT OWNER LOCATION. IE.
- DEMOLITION NOTES. CAMERAS, SECURITY, ETC.
- REMOVE EXISTING WALL.
- REMOVE EXISTING FOLDING WALL ASSEMBLY, HARDWARE, OVERHEAD TRACK, ETC., IN THEIR ENTIRETY.
- REMOVE EXISTING DOOR, FRAME & HARDWARE.
- REMOVE EXISTING CASEWORK. (RETAIN AT OWNER REQUESTS)
- REMOVE EXISTING FLOOR FINISH.
- REMOVE EXISTING CEILING SYSTEM, LIGHT FIXTURES, SMOKE DETECTORS, STROBE LIGHTS
- REMOVE PORTION OF EXISTING WALL FOR NEW DOOR OPENING. REFERENCE FLOOR PLAN.
- EXISTING FLOOR FINISH TO REMAIN. REPLACE DAMAGED AREA AS REQUIRED.
- REMOVE EXISTING WOOD TRIM, BASE AND PLYWOOD FROM COLUMNS, WALLS AND CEILING.
- REMOVE AND SALVAGE EXISTING FIRE EXTINGUISHER AND CABINET. REF. PLAN FOR RELOCATION.
- CONTRACTOR TO COORDINATE WITH OWNER REMOVAL OF FOOD / BEVERAGE VENDOR EQUIPMENT. 11 x 17 = 1/2 scale

Contract Date Rev No. 2 Rev No. 3 Rev No. 4 Rev No. 5 Rev No. 6 Project Number: DWG File Designed By: Drawn By: Approved By: 03.25.24 Date:



FINISH MATERIAL LIST

BASE

F-1	FLOOR TIL	E
		ANATOLIA / VIRGINIA TILE INDUSTRIA HD PORCELAIN TILE
		LITHIUM, RECTIFIED
	SIZE:	24"X48"x13/32"
		SCHLUTER ALL-SET, GRAY DLATION BARRIER: SCHLUTER DITRA
		TEC POWER GROUT - SLATE GRAY
	PATTERN:	33% OFFSET
F-2	CARPET T	ILE
		J&J INVISION
	STYLE: COLOR:	
	SIZE:	
	—	QUARTER TURN
	NOTE:	FIELD VERIFY, REPLACE AS REQUIR
<u>WAL</u>	_L TILE/PAI	<u>VELS</u>
<i>N</i> -1	BACKSPLAS	H TILE
	MFR: E	EQUIPE CERAMICAS/ M&S

COLOR: AMBER GREY MATTE SIZE: 2" X 6" MORTAR: TEC DOUBLE DUTY GROUT: TEC POWER GROUT, SLATE GRAY PATTERN: VERTICAL 50% OFFSET

UNDER BAR WALL TILE MFR: EQUIPE CERAMICAS/ M&S STYLE: COCO COLOR: BLACK HAT MATTE SIZE: 2" X 6" MORTAR: TEC DOUBLE DUTY GROUT: TEC POWER GROUT, RAVEN PATTERN: VERTICAL 50% OFFSET

WALL TILE @ FIREPLACE LOUNGE MFR: CAESAR CERAMICHE - VIRGINIA TILE STYLE: RELATE COLOR: MINE SIZE: 12" X 24" X 3/8" MORTAR: TEC DOUBLE DUTY PLUS ADHESIVE GROUT: TEC POWER GROUT - RAVEN

PATTERN: VERTICAL 33% OFFSET PERFORATED METAL PANELS MFR: MOZ MTRL: .063" PERFORATED ALUMINUM 3/16" DIA. BY 5/16" STG. CTRS. COLOR: CLASSIC KHAKI FOG MATTE SIZE: VARIES W-5 FROSTED RESIN W/ PERFORATED METAL PANEL

MFR: 3FORM WALL STYLE: FULLY FRAMED, TOP SUPPORT PARTITION HRDW: JET BLACK MATTE STYLE: CUSTOM DIGITAL PRINT MATERIAL: VARIA 3/8" FINISH: SANDSTONE F01 FINISH

PLYWOOD WALL PANEL MFR: STYLE: COLOR: ST-1 SIZE: VARIES FRP WALL PANEL

NOTES TO FINISH:

PROPER CURING TIME.

VISIBLE TO THE NAKED EYE.

STYLE: ARTIZAN CEMENT FINISH COLOR: 2410 - SKY NATURAL CONCRETE SIZE: 4'-0" x 10'-0"

REF SHEET A121 CEILING PLAN FOR FINISH LOCATIONS.

1. FOLLOW PROPER TILE SETTING, GROUT APPLICATION AND DRYING

3. FOLLOW INSTRUCTIONS FOR WEEKLY/DEEP CLEAN CLEANING USING A

4. ALLOW FLOOR TO COMPLETELY DRY. FLOOR SHOULD THEN BE READY TO

5. ALL TILE SHOULD BE COVERED WITH RAM BOARD, PLYWOOD OR A SIMILAR

6. NO CONSTRUCTION DUST, DIRT, OR GRIME SHOULD TOUCH THE PROPERLY CLEANED FLOOR. THIS IS DETRIMENTAL TO THE LONG-TERM CARE OF THE

2. DO NOT WALK ON THE FLOOR FOR AT LEAST 72 HOURS. GROUT MUST HAVE THE

"HEAVY-DUTY STONE, TILE AND GROUT CLEANER" TO REMOVE GROUT HAZE

FROM INITIAL INSTALLATION. MOST LIKELY, THERE WILL BE GROUT HAZE NOT

2. ALL WALLS AT 9' A.F.F. ON UP, TO BE PAINTED PT-2.

MATERIAL AT ALL TIMES PRIOR TO OPENING.

NOTES FOR TILE INSTALLATION

TILE BASE @ NON-TILED WALLS

COLOR: LITHIUM, RECTIFIED

SIZE: 12"X24"X13/32" CUT -

BASE @ CASEWORK

TRACELSS FINISH

STYLE: RELATE

COLOR: MINE

BASE @ CARPET

MFR: WILSONART

MOUNT ON 3/4" PLYWD.

COLOR: CHARCOAL VELVET,

SIZE: 12"X24"X3/8" CUT -

TILE BASE @ NON-TILED WALLS w/ PT-2

MFR: CAESAR CERAMICHE-VIRGINIA TILE

4" FINISHED HEIGHT

TOP TRIM: SCHLUTER QUADEC 7/16", DARK

WALL BASE, RUBBER

ANTHRACITE TEXTURED

MORTAR: SCHLUTER ALL-SET, GRAY

MFR: JOHNSONITE TRADITIONAL

COLOR: CHARCOAL 4" W/ TOE

ADHESIVE: PARABOND FUSION X

GROUT: TEC POWER GROUT - RAVEN

MFR: ANATOLIA / VIRGINIA TILE

STYLE: INDUSTRIA HD PORCELAIN TILE

PRIMER SHERWIN WILLIAMS: PROMAR 200 PRIMER (B28W2600) (INTERIOR WALLS & CEILING) PT (1 PRIME COAT, 2 FINISH COATS)

4" FINISHED HEIGHT MORTAR: SCHLUTER ALL-SET, GRAY MFR: SHERWIN WILLIAMS - SUPER PAINT GROUT: TEC POWER GROUT - SLATE GRAY COLOR: UNCERTAIN GRAY SW 6234 TOP TRIM: SCHLUTER QUADEC 7/16", LIGHT FINISH: SATIN ANTHRACITE

PAINT

WALL PAINT MFR: SHERWIN WILLIAMS - SUPER PAINT COLOR: IRON ORE SW 7069 FINISH: FLAT

WALL PAINT - ACCENT MFR: SHERWIN WILLIAMS - DURATION HOME COLOR: CUSTOM MATCH, SW 6868 REAL RED BASE FINISH: MATTE

WALL PAINT MFR: SHERWIN WILLIAMS - SUPER PAINT COLOR: EXTRA WHITE SW 7006 FINISH: SATIN

WALL PAINT MFR: SHERWIN WILLIAMS - SUPER PAINT COLOR: EVENING SHADOW 7662 FINISH: SATIN

CEILING PAINT MFR: SHERWIN WILLIAMS - SUPER PAINT COLOR: EXTRA WHITE SW 7006 FINISH: MATTE

CEILING PAINT MFR: SHERWIN WILLIAMS - SUPER PAINT COLOR: IRON ORE SW 7069

CEILING TILE CLOUD

COLOR: WHITE

COLOR: WHITE

MFR: USG

USG

SIZE: 24" x 24" x 1"

COLOR: FLAT BLACK

COLOR: FLAT BLACK

SIZE: 24" x 24" x 1"

CEILING TILE PERFORATED

CEILING TILE UPPER CEILING

PANEL: HALCYON - FL #98225

ARKTURA

2'x4'x1-1/2"

GYP. BD. CLG. TO BE PAINTED. SEE

PANEL: HALCYON - FL #98225

DONN BRAND IDENTITEE DXI FINELINE

GRID: DONN BRAND IDENTITIEE DXI FINELINE

STYLE: VAPOR VERVE W/ FROSTED BACKER

POWDER COAT W/ FROSTED BACKER

COLOR: T-GRID WHITE (MATTE) ALUMINUM

MFR:

MFR:

MFR: SHERWIN WILLIAMS - SUPER PAINT CEILING COLOR: IRON ORE SW 7069 FINISH: FLAT

COUNTERTOPS QUARTZ @ COUNTERTOP MFR: MSI Q QUARTZ

COLOR: MARBELLA WHITE

MFR: MINWAX

COLOR: HABITAT MW 427

HOLLOW METAL FRAMES

CASEWORK

DOORS

DOOR AND FRAME

ST-1 WOOD DOORS

PL-1 CABINETRY MFR: WILSONART TRACELESS COLOR: CHARCOAL VELVET 15504-31

PL-2 CABINETRY MFR: WILSONART PRODUCT: SOLICOR HORIZONTAL GRADE LAMINATE .048" - 161 COLOR: CHARCOAL VELVET 15504-31

TRACELISS FINISH W/ EDGES

GYP. BD. CLG. TO BE PAINTED. SEE

C-3

CABINETRY DOOR PULL MFR: HARDWARE RESOURCES ELEMENTS STYLE: KNOX, 128MM


CABINETRY DRAWER PULL STYLE: KNOX, 224MM COLOR: MATTE BLACK 645-224MB

PULLS/ HANDLES

COLOR: MATTE BLACK 645-128MB

HARDWARE RESOURCES ELEMENTS

	FINISH SCHEDULE									
ROOM#	ROOM NAME	FLOOR FINISH	BASE FINISH	NORTH WALL	EAST WALL	SOUTH WALL	WEST WALL	CEILING FINISH	NOTES	
200	HALLWAY	OWNER'S STOCK	EXISTING	PT-5	PT-5	PT-5	PT-5	EXISTING	-	
201	STORAGE	OWNER'S STOCK	B-4	PT-5	PT-5	PT-5	PT-5	C-4	-	
202	CONERENCE ROOM	F-1	B-1/B-2/B-3	PT-4/PT-1/W-4	PT-1/PT-2/W-4	PT-4/W-4	PT-4	C-1 / C-2 / C-4	-	
203	BREAK ROOM	F-1	B-1	PT-4/PT-2/W-4	PT-1/W-4	PT-1	PT-4	C-1 / C-2 / C-4	-	
204	COLLABORATION	F-1	B-3	PT-1	PT-2/PT-1	PL-2/W-4	PT-2	C-4 / C-1	-	
205	LARGE LOUNGE	F-1	B-1/B-3	PT-2	PT-2/ PT-1	PT-2	PT-2/W-3	C-3 / C-4	-	
206	SMALL LOUNGE	F-1	B-1	W-5/PT-2	-	PT-1	PT-4	C-4	-	
207	STAFF KITCHEN	F-1	B-1/B-2	PT-3	PT-2	PT-2	PT-2/W-4	C-1	-	
208	CATERING KITCHEN	F-1	B-1/B-2	PT-1	PT-2/ PT-1	PT-1	W-7	C-1	-	
209	BREAK ROOM	F-1	B-1/B-3	PT-1/W-4	PT-4	PT-2	PT-2/PT-3/PT-1/W-2	C-1 / C-2 / C-4	-	
210	BREAK AREA	F-1	B-1/B-2	PT-5	PT-5/W-4/PT-2	PT-2/W-1/PT-5	PT-2/PT-5	C-1 / C-4	-	

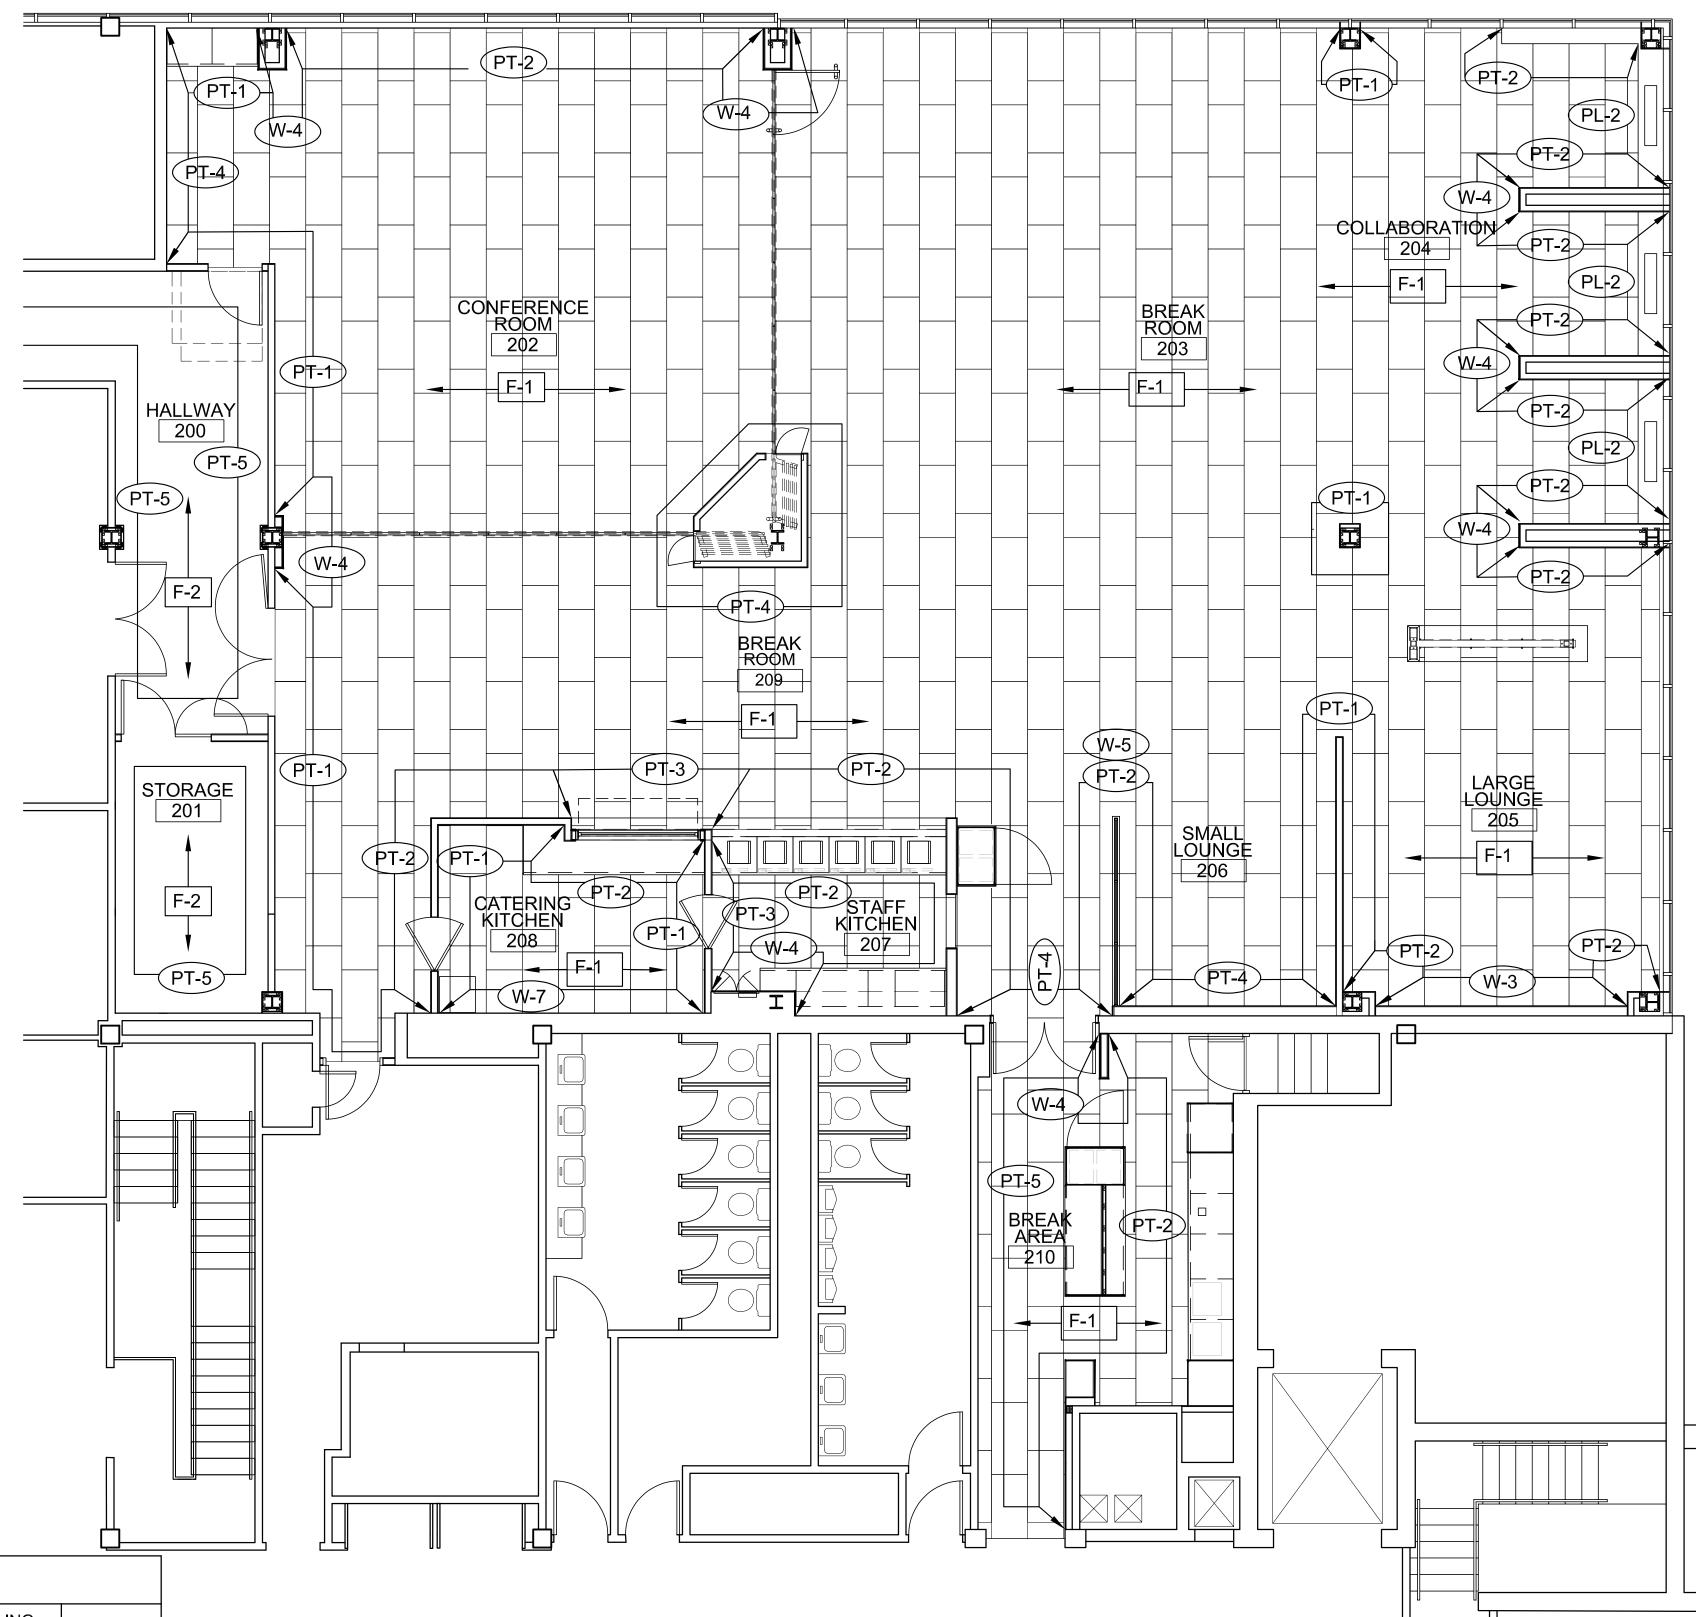




11 x 17 = 1/2 scale

Contract Date

Rev No. 1 Rev No. 2 Rev No. 3 Rev No. 4 Rev No. 5 Rev No. 6 Project Number: DWG File A010.dwg Designed By: plan4 Drawn By: Approved By: plan4 03.25.24 Date:



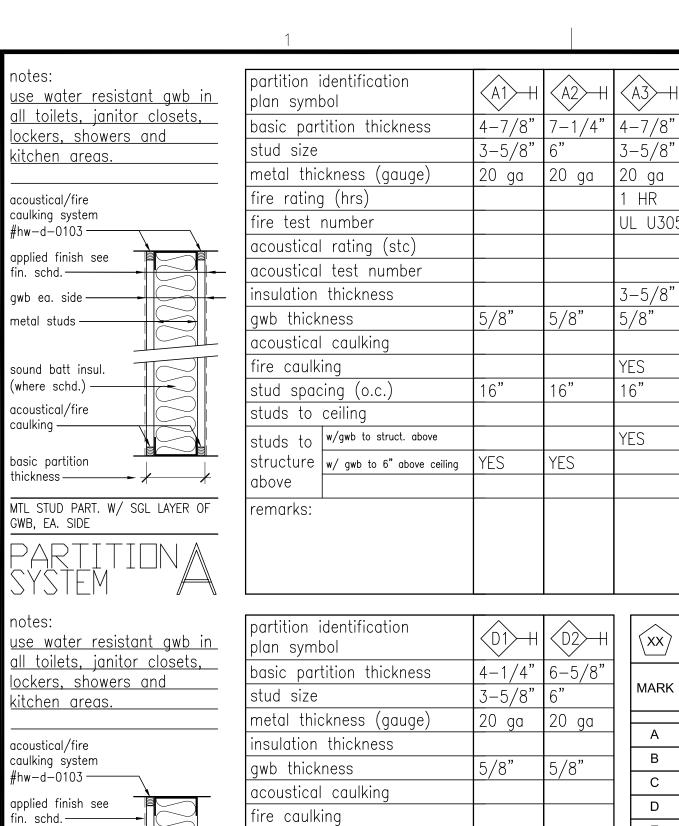

stud spacing (o.c.)

studs to ceiling

above

remarks:

studs to | w/ base gwb to struct. above

structure | w/ gwb to 6" above ceiling | YES

gwb, (1) layer,

sound batt insul. (where schd.)-

acoustical/fire

asic partition

ITL STUD PART. W/ SGL LAYER ON

hickness —

ONE SIDE

aulking —


symbol side – netal studs -


$\langle xx \rangle$	WIN	DOW	COV	ERING SCHEDULE
MARK	ROOM NUMBER	WIDTH	HEIGHT	NOTES
А	205	9'-0"	7'-0"	(1) WALL MNTD SWITCH FOR RM 205
В	205	8'-0"	7'-0"	(1) WALL MNTD SWITCH FOR RM 205
С	205	7'-8"	7'-0"	(1) WALL MNTD SWITCH FOR RM 205
D	204	8'-0"	4'-4"	(1) WALL MNTD SWITCH PER BOOTH IN RM 204
E	204	7'-8"	4'-4"	(1) WALL MNTD SWITCH PER BOOTH IN RM 204
F	203	7'-10"	7'-0"	(1) WALL MNTD SWITCH IN RM 203
G.1	203	5'-7"	9'-0"	(1) WALL MNTD SWITCH IN RM 203
G.2	203	1'-9"	7'-0"	(1) WALL MNTD SWITCH IN RM 203
Н	203	8'-0"	9'-0"	(1) WALL MNTD SWITCH IN RM 203
J	203	7'-0"	9'-0"	(1) WALL MNTD SWITCH IN RM 203
К	202	7'-5"	2'-0"	(1) WALL MNTD SWITCH IN RM 202
L	202	12'-0"	2'-0"	(1) WALL MNTD SWITCH IN RM 202
М	202	7'-0"	2'-0"	(1) WALL MNTD SWITCH IN RM 202

NOTE TO WINDOW COVERING SCHEDULE: BASIS OF DESIGN: "ALTA" ROLLER SHADE W/ BLISS AUTOMATION. SQUARE CASSETTE, BLACK. R80-1% E-SCREEN 09 CHARCOAL/ CHARCOAL FARBIC. 2.0 NM DC MOTOR. OMNI CURVE FABRIC WRAPPED BOTTOM RAIL, BLACK. 15V DC DISTRIBUTION PANEL POWER SUPPLY, PROVIDE COLOR SAMPLES FOR APPROVAL. 2. FIELD VERIFY ALL MEASUREMENTS.

							DOOR S	CHEDULE	•					
MARK	FROM ROOM: NUMBER	TO ROOM: NUMBER	WIDTH	HEIGHT	THICKNESS	DOOR TYPE	DOOR MATERIAL	DOOR FINISH	FRAME MATERIAL	FRAME FINISH	FRAME TYPE	HARDWARE SET	FIRE RATING	COMMENTS
201/01	200	201	4'-0"	7'-0"	1 3/4"	D1	SC - WOOD	PAINT - PT-2	H.M 16 ga.	F.F PT-2	F1	1.0	45 MIN	PAIR OF DOORS, 36" & 24"
202/01	202	200	3'-0"	7'-0"	1 3/4"	D2	SC - WOOD	PAINT - PT-2	H.M 16 ga.	F.F PT-2	F1	2.0	45 MIN	
202/02	202	209	22'-10"	9'-0"	1 1/4"	D5	TEMP. GLASS	CLEAR	ALUM.	ANODIZED BLACK	MANUF.	3.0	-	NANA WALL SYSTEM - HSW75-C
202/03	202	203	21'-4"	9'-0"	1 1/4"	D6	TEMP. GLASS	CLEAR	ALUM.	ANODIZED BLACK	MANUF.	3.0	-	NANA WALL SYSTEM - HSW75-C
207/01	207	208	3'-0"	7'-0"	-	D4	PVC / ABS	FF - BLACK	H.M.	F.F.	-	4.0	-	SEE NOTE 1
208/01	208	209	3'-0"	7'-0"	-	D4	PVC / ABS	FF - BLACK	H.M.	F.F.	-	4.0	-	SEE NOTE 1
209/01	209	200	6'-0"	7'-0"	1 3/4"	D3	SC - WOOD	PAINT - PT-2	H.M 16 ga.	F.F PT-2	F1	5.0	45 MIN	PAIR OF DOORS, 36" & 36"
209/02	209	-	3'-0"	7'-0"	1 3/4"	D2	SC - WOOD	PAINT - PT-2	H.M 16 ga.	F.F PT-2	F1	6.0	45 MIN	
209/03	209	210	EX - 6'-0"	EX - 7'-0"	EX - 1 3/4"	-	EX	PAINT - PT-2	EX	EX - PT-2	EX	7.0	EXIST	EX. PAIR OF DOORS, 36" & 36", SEE NOTE 2

NOTE TO DOOR SCHEDULE: BASIS OF DESIGN: "CHASE DOORS" PROLINE 300i WITH WINDOW. PROVIDE COLOR SAMPLES FOR APPROVAL. 2. EXISTING DOOR, SAND AND PREP FOR NEW STAIN. REMOVE HARDWARE AS NEEDED TO REFINISH DOOR

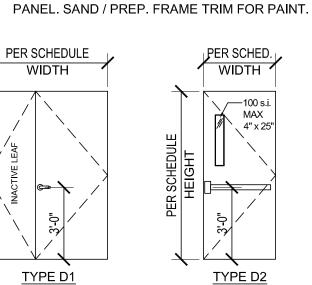

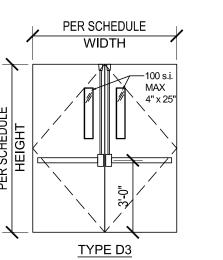

|뿌 MANUF:

MODEL:

FoldUp Window Series 5000

COLOR: Black Frame

In-Line Fold-Up Out

Window Unit with Countertop Sill

GLAZING: Custom 3Form Resin Panel

STYLE: Custom Digital Print


MATERIAL: Varia 3/8" - Black


FINISH: Sandstone F01 Finish


A020


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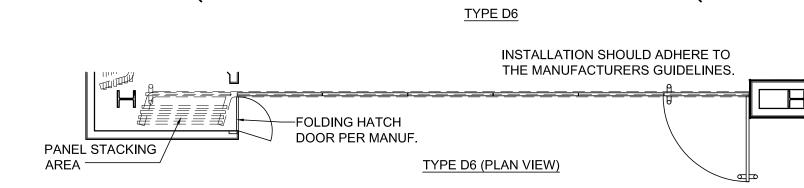
TYPE (A). /




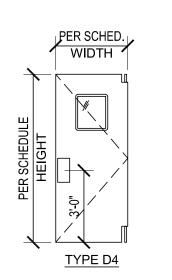

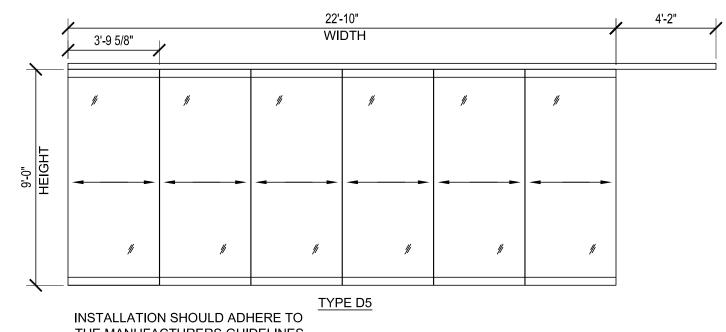


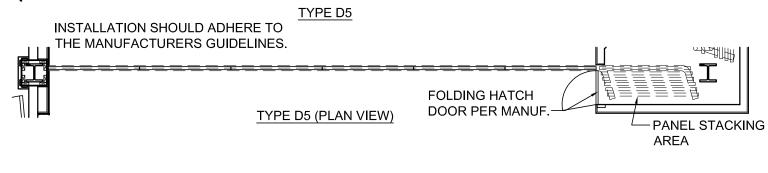

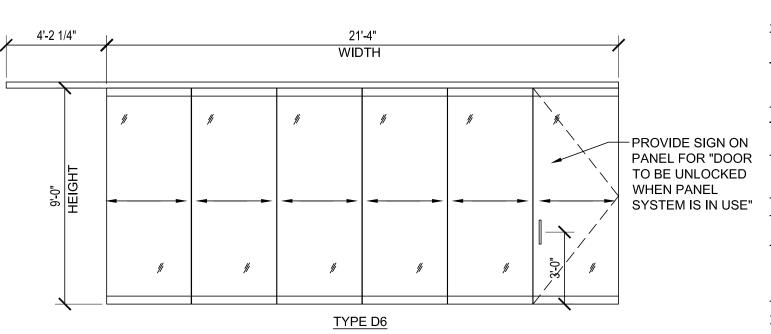

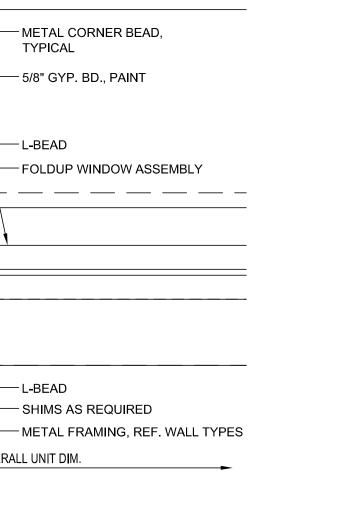

	. BD., PAINT—			
FOLDUP ASSEME	WINDOW BLY			
	RAMING, LL TYPES——			
	OVERALL !	JN I T DIM.		

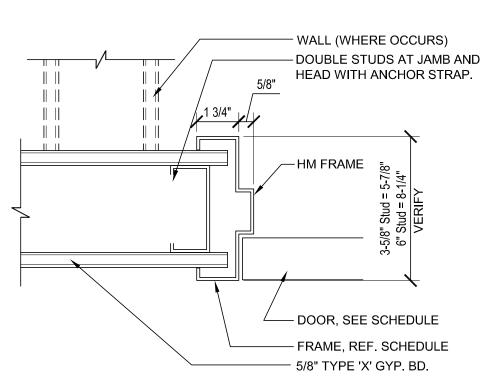

11 x 17 = 1/2 scale

METAL FRAMING, REF. WALL TYPES 5/8" GYP. BD. L-BEAD	BOX BEAM 5/8" GYP. BD., PAINT METAL CORNER BEAD -5/8" GYP. BD., PAINT -1/2" PLYWOOD FURRING -L-BEAD
L-BEAD	
MIQ El	-L-BEAD
OVERALL UNIT DIM.	-FOLDUP WINDOW ASSEMBLY

WINDOW JAMB DETAIL
SCALE: 3"=1'-0"

TYPE F1

TYPICAL

— L-BEAD

- L-BEAD

OVERALL UNIT DIM.

(A4) WINDOW JAMB DETAIL
SCALE: 3"=1'-0"

DOOR JAMB DETAIL

SCALE: 3"=1'-0"

Alliance


Rev No. 3 Rev No. 4 Rev No. 5 Rev No. 6 Project Number: DWG File A020.dwg Designed By: plan4 Drawn By: Approved By: plan4 03.25.24 Date:

Contract Date

Rev No. 1


Rev No. 2




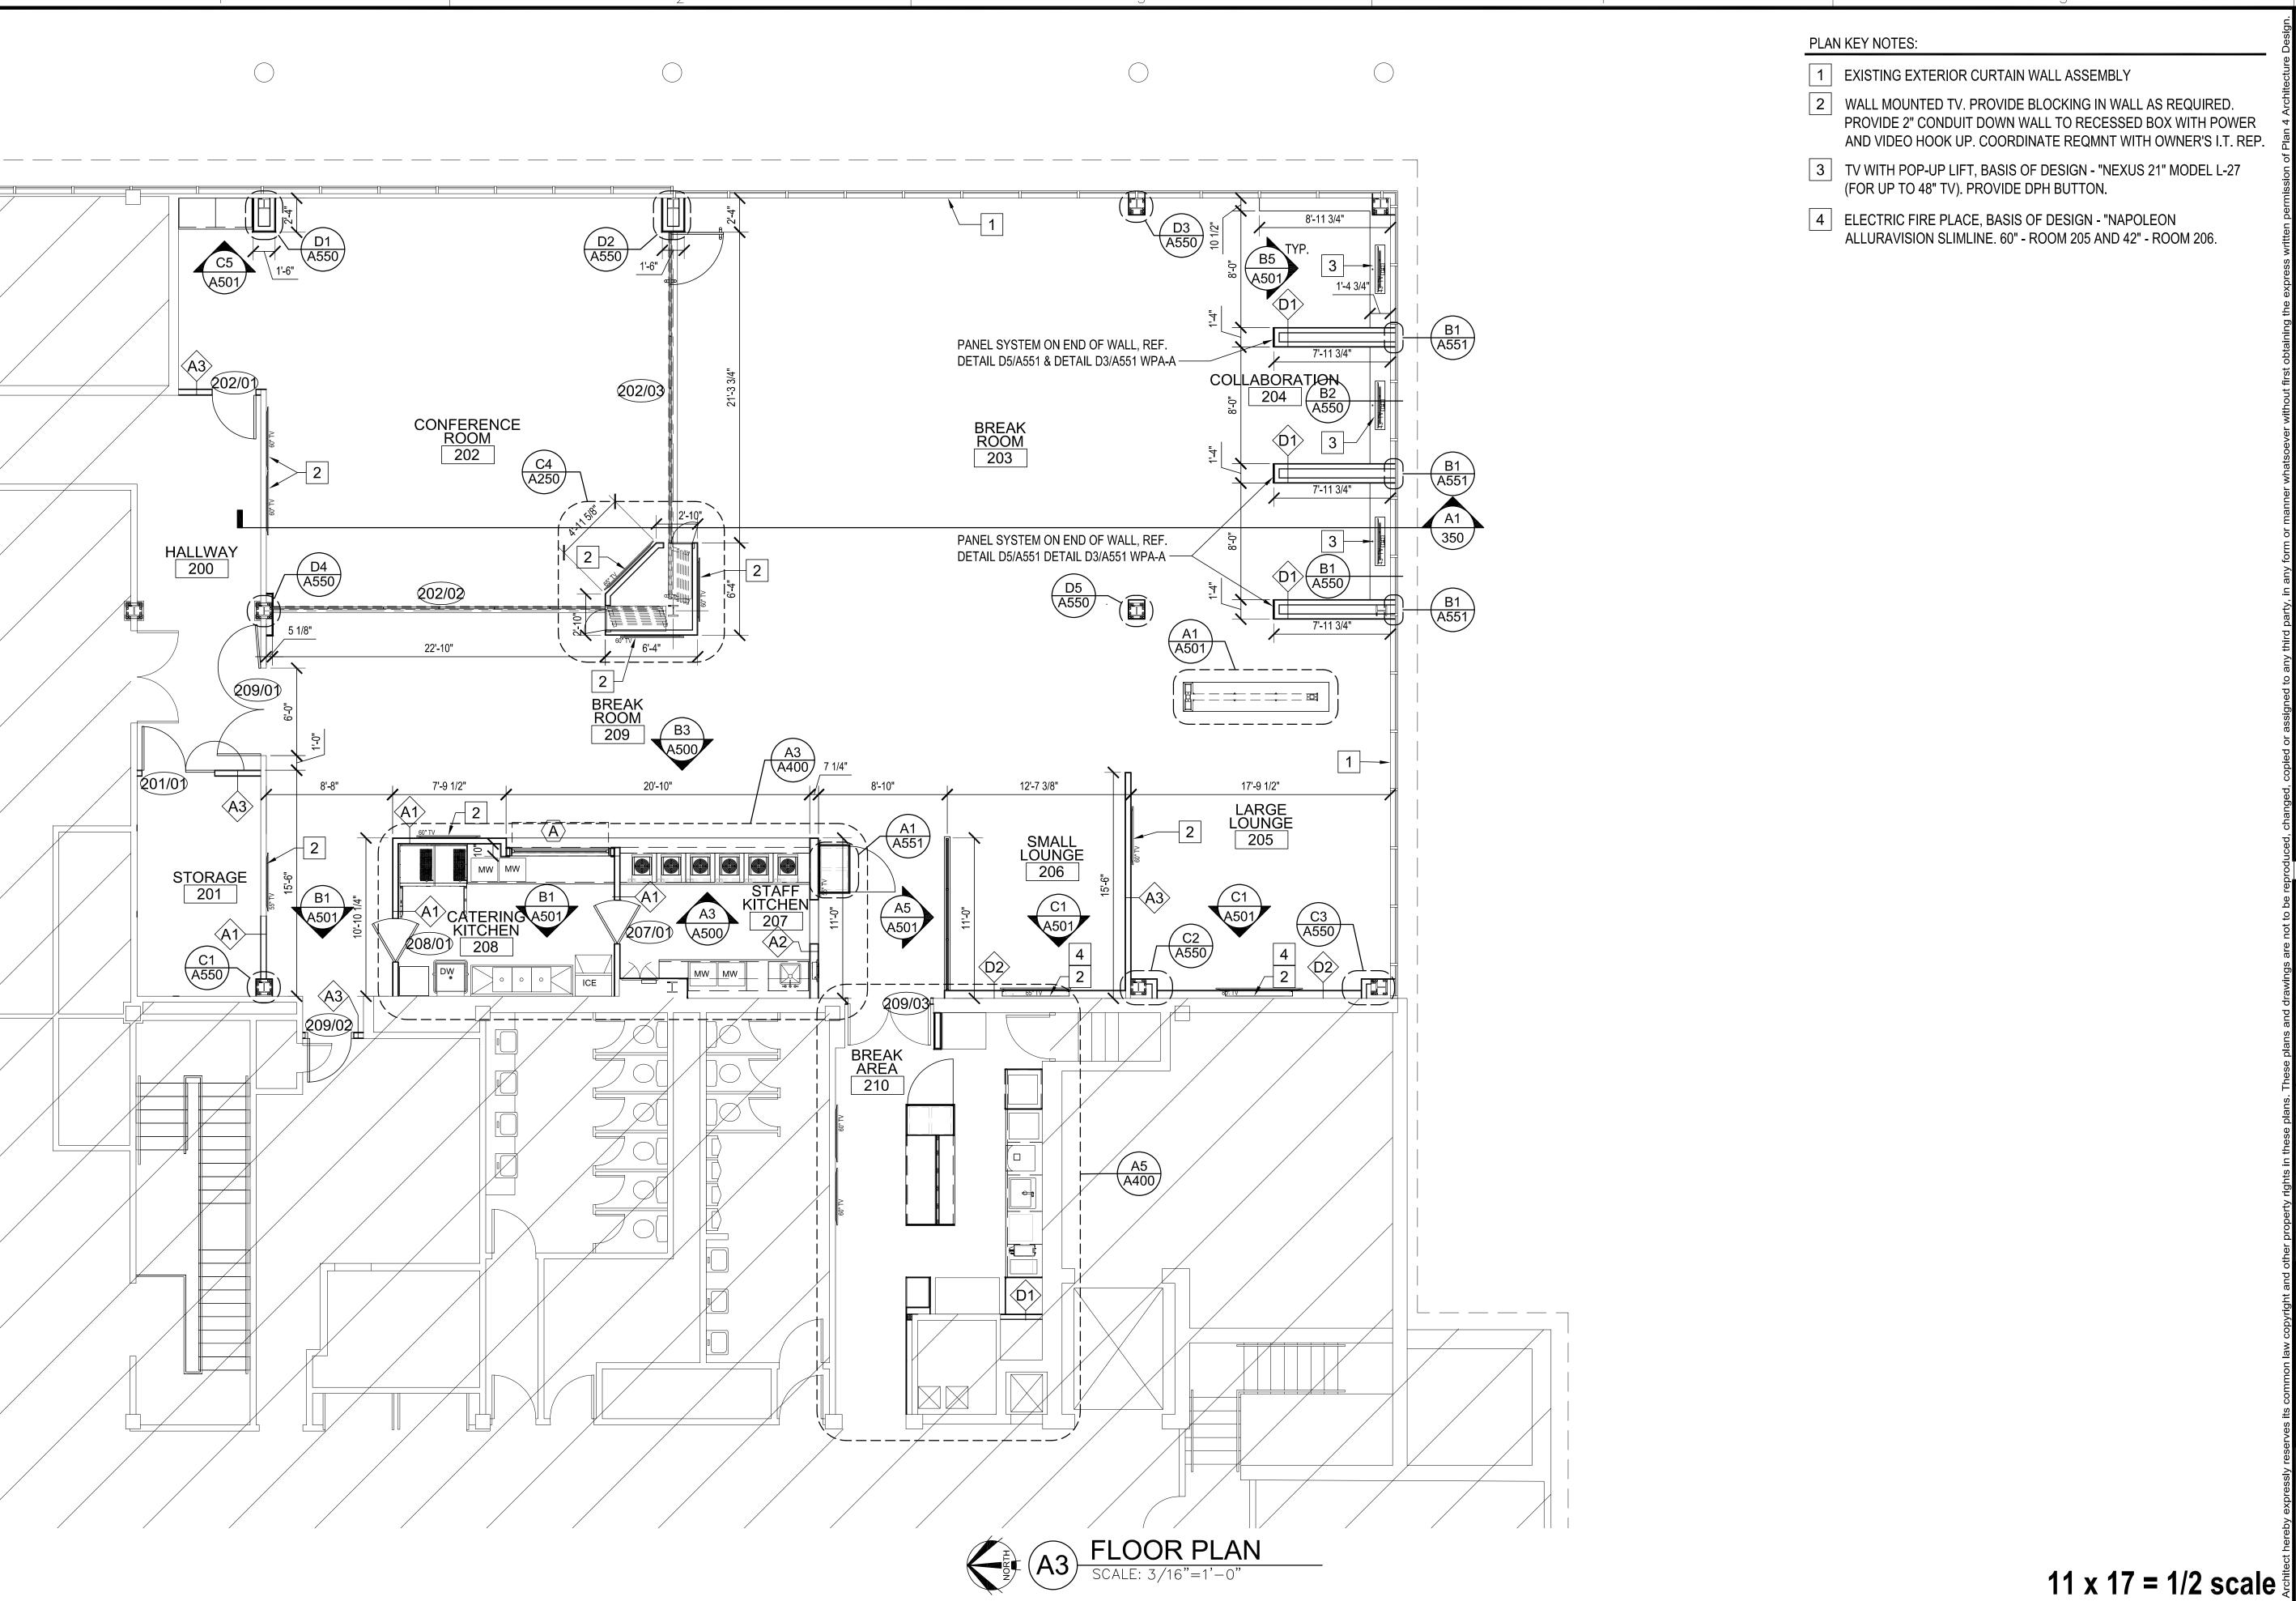


Contract Date Rev No. 2 Rev No. 3 Rev No. 4 Rev No. 5 Rev No. 6 Project Number: DWG File Designed By: Drawn By: Approved By: plan4 03.25.24



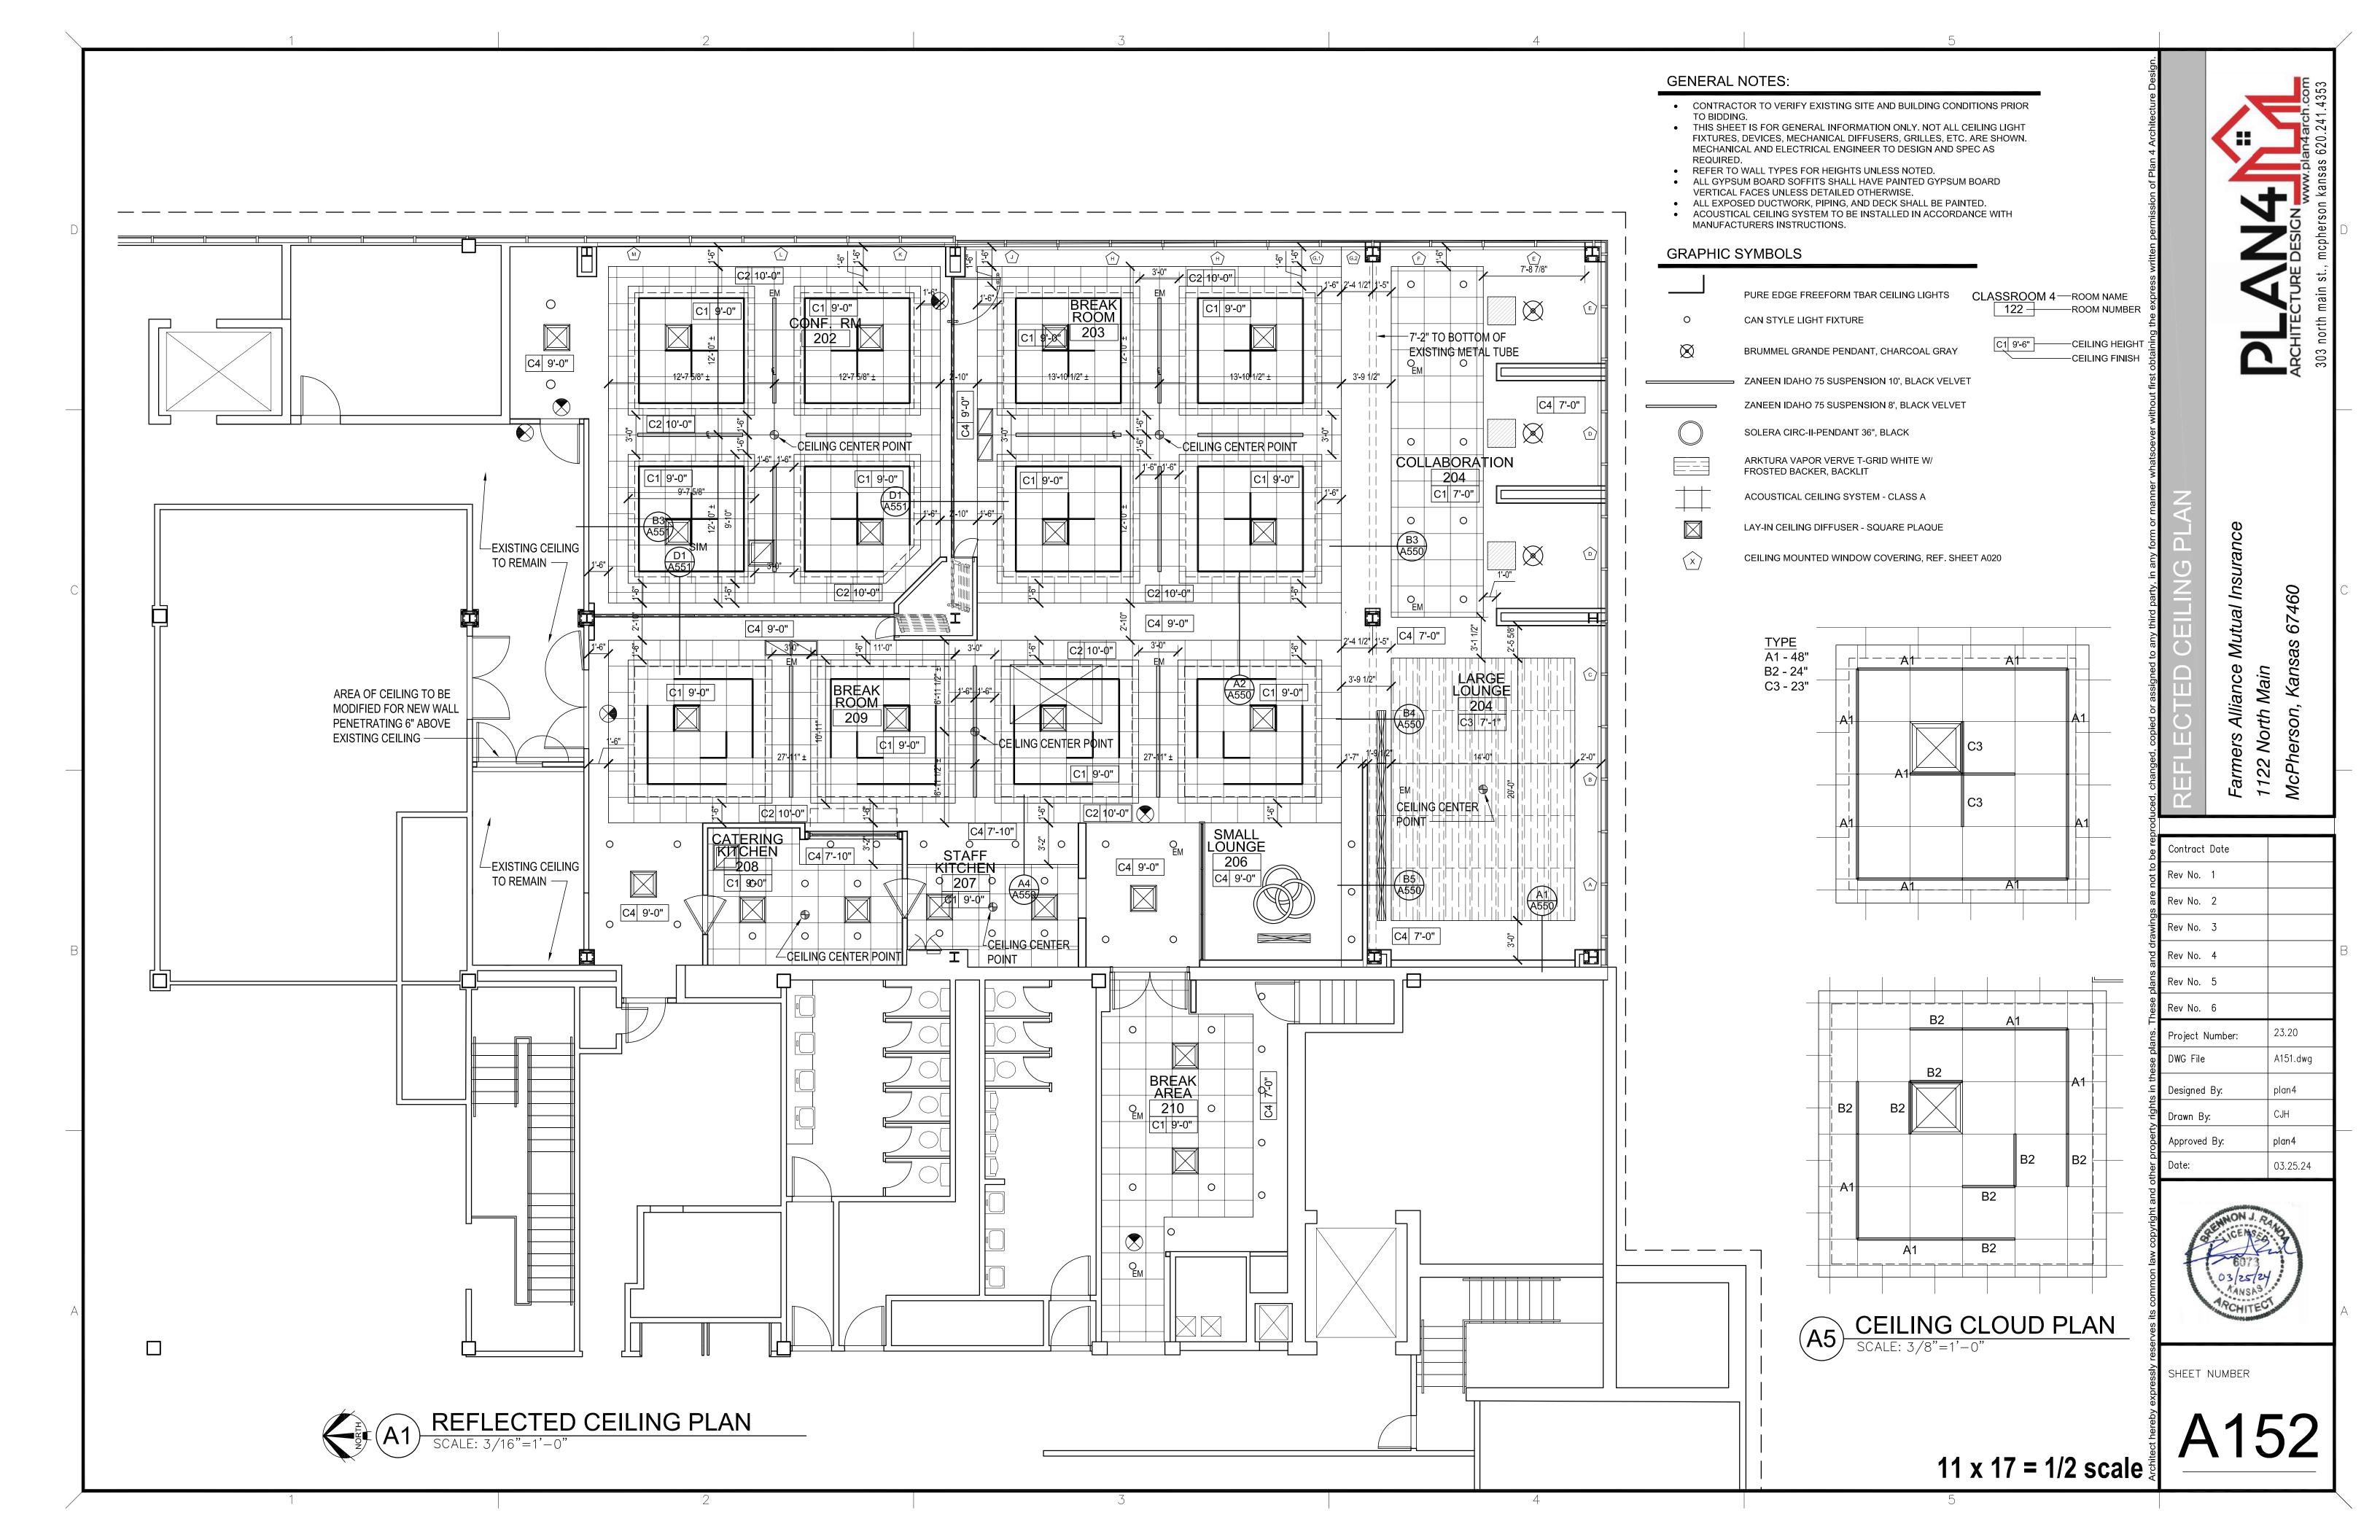

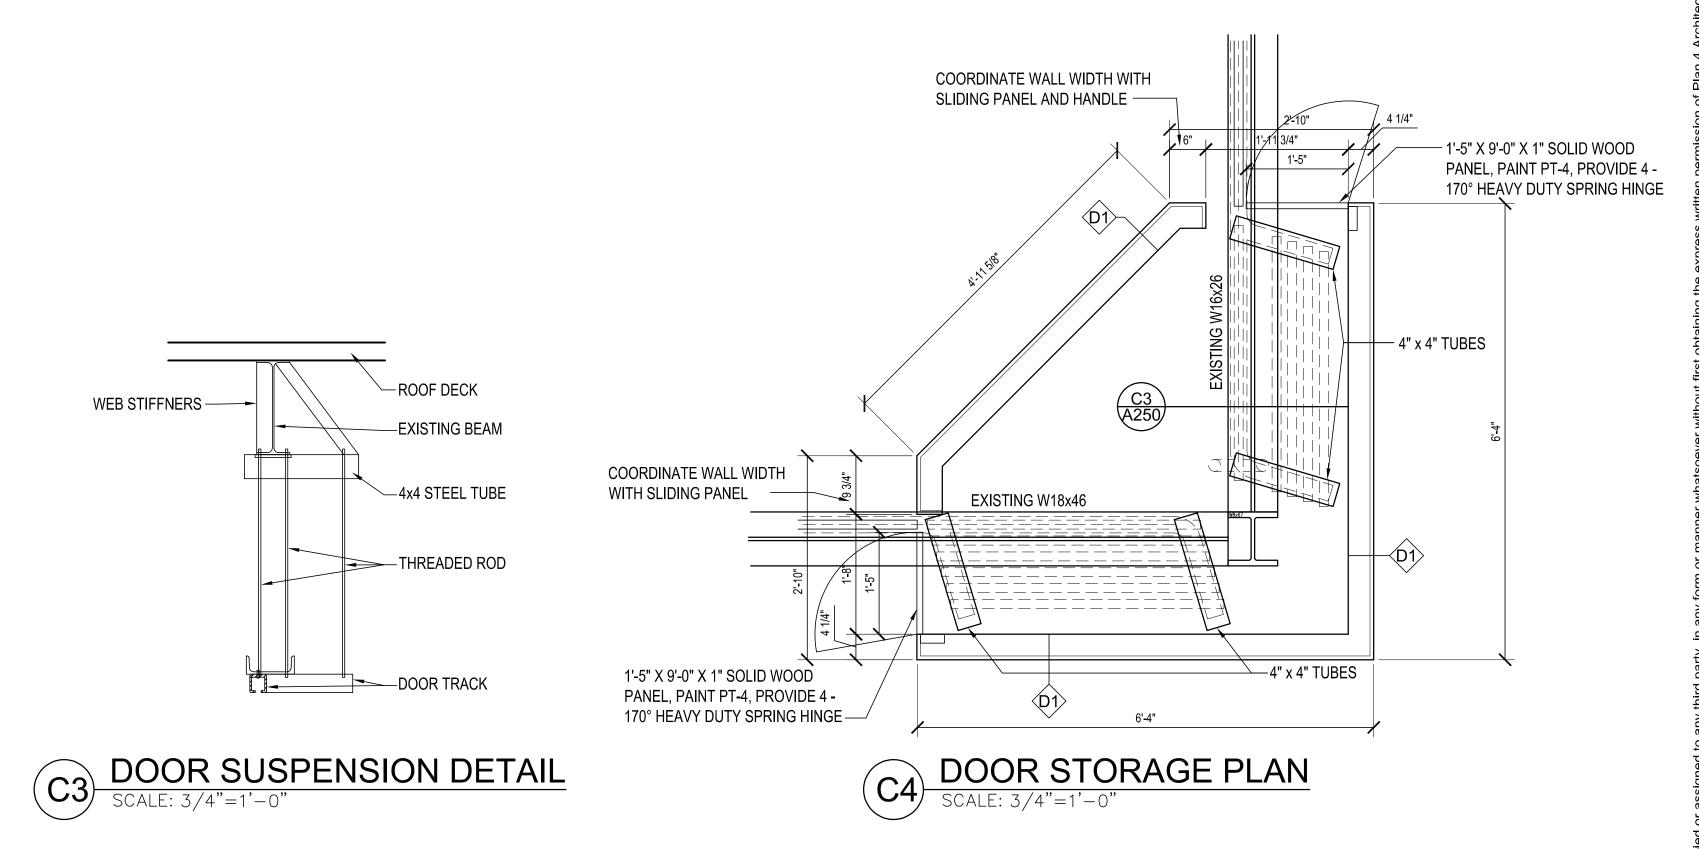

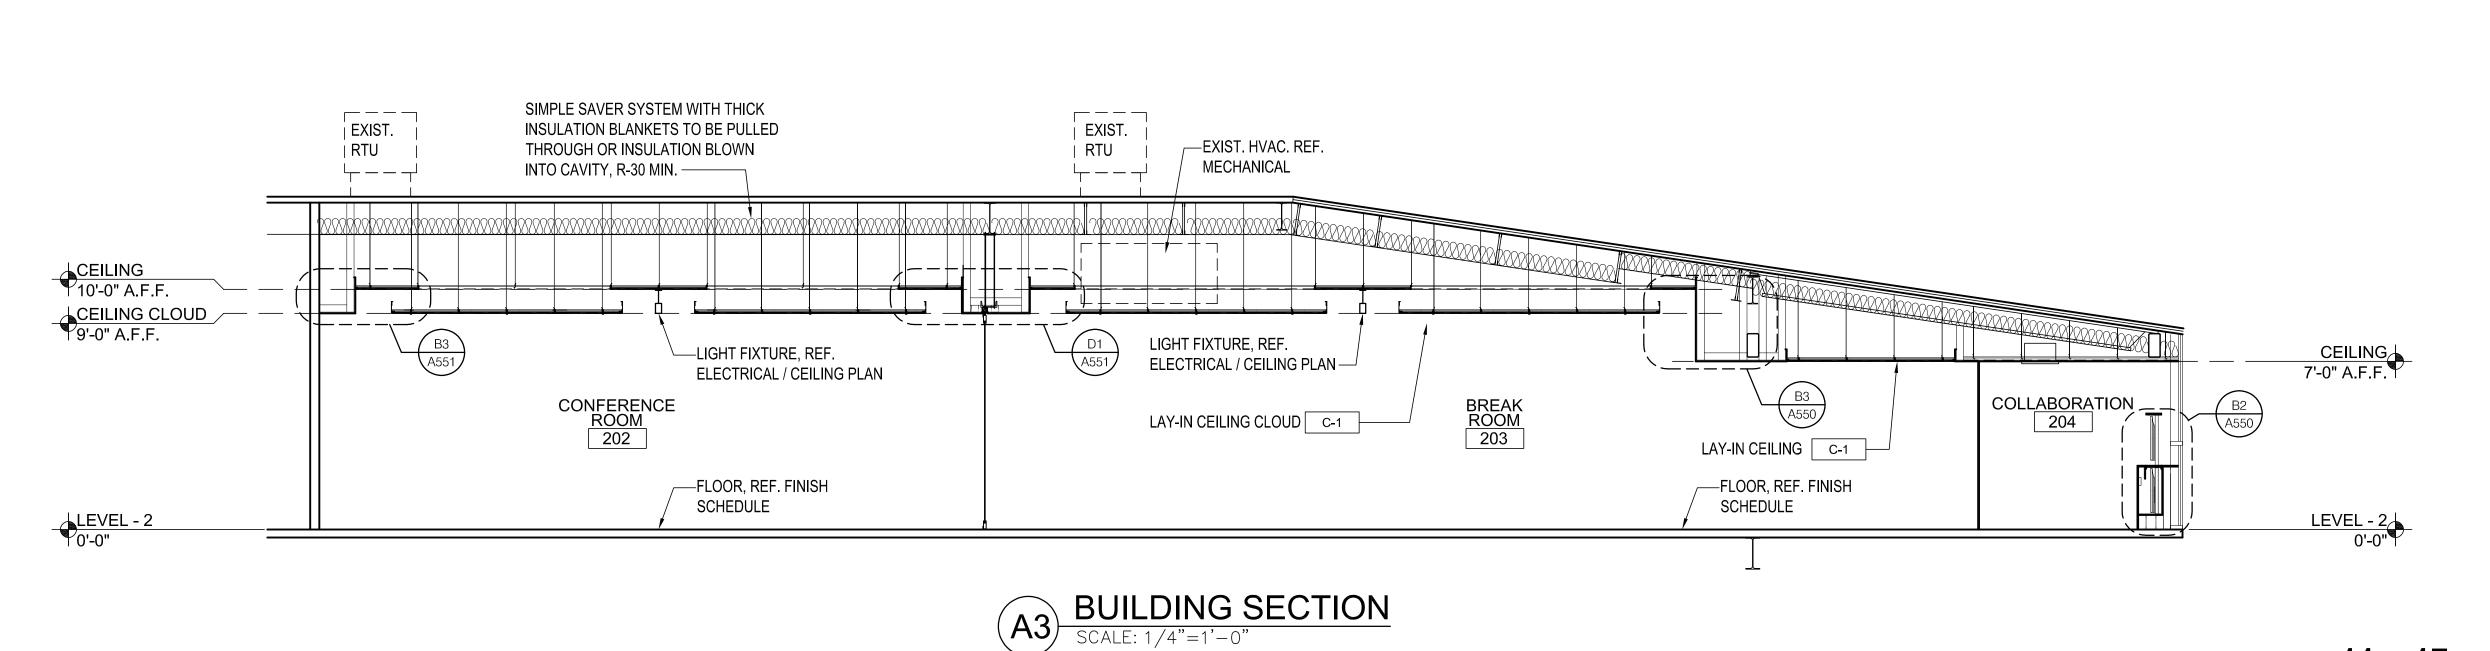

BUILDING SECTION

Contract Date

Rev No. 1

Rev No. 2

Rev No. 3

Rev No. 4

Rev No. 5

Rev No. 6

Project Number: 23.20

DWG File

Designed By: plan4

Drawn By: GSC

Approved By: plan4

Date: 03.25.24


Farmers Alliance Mutual Insurance 1122 North Main



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A250

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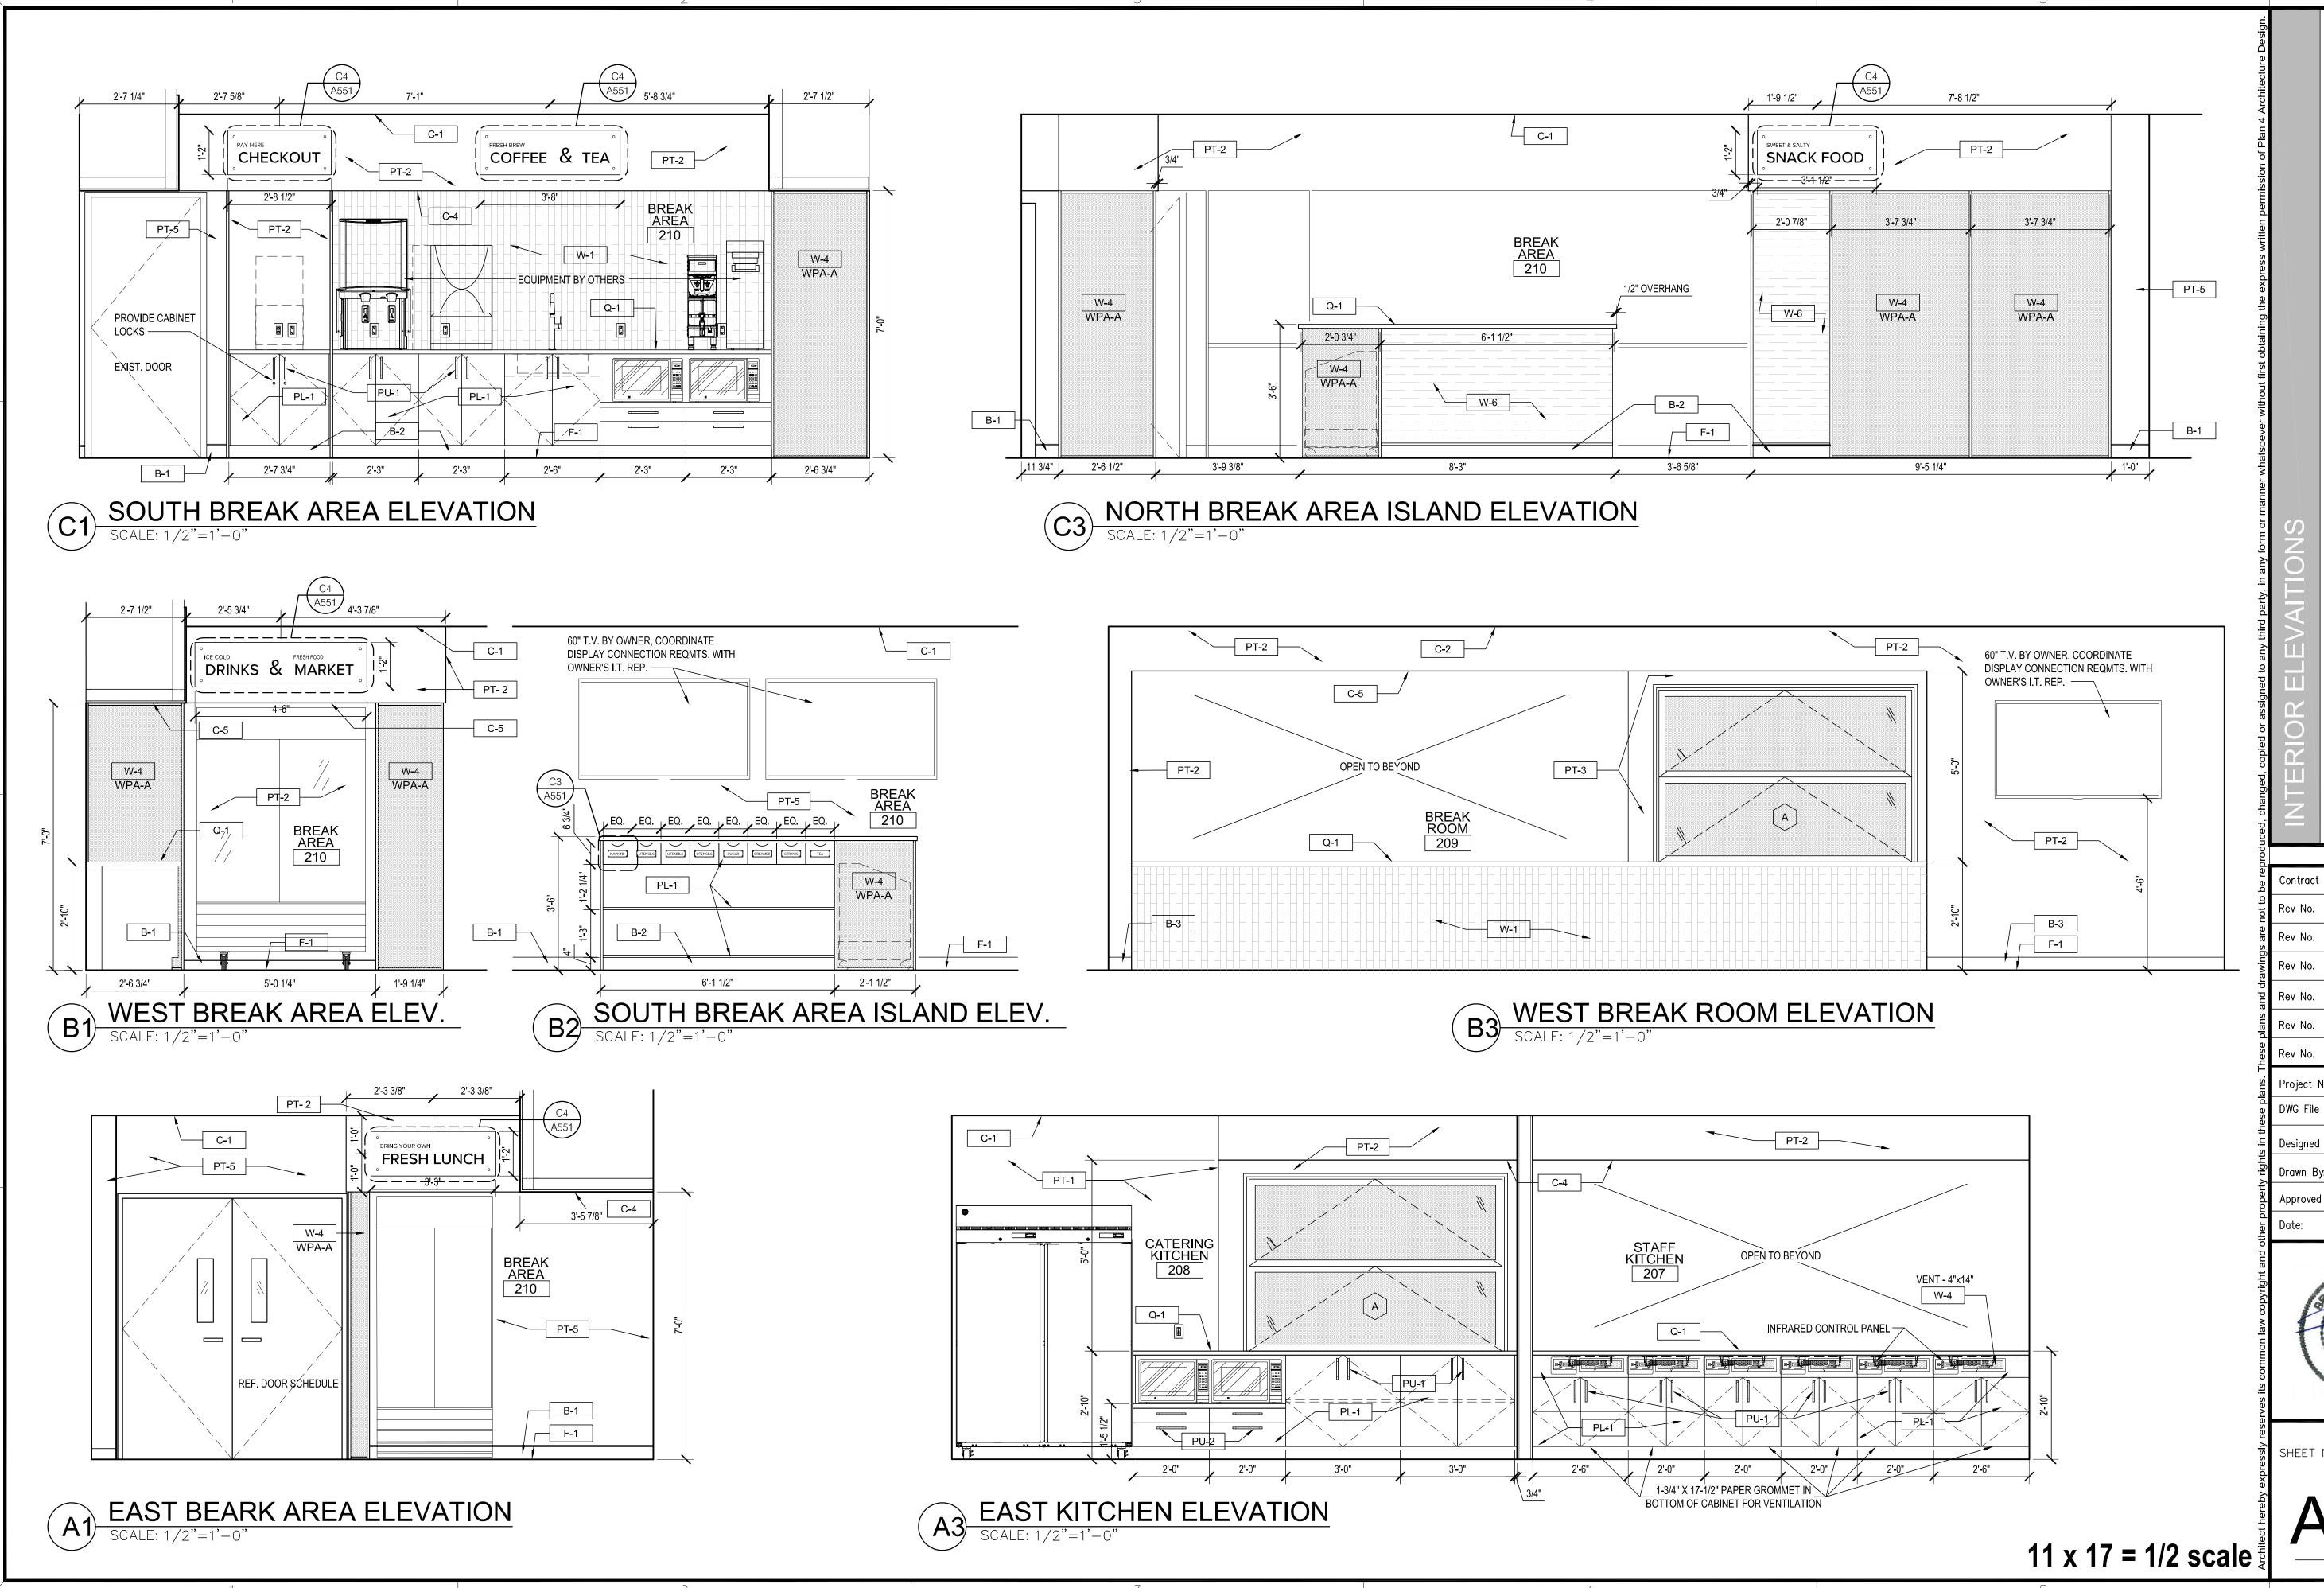
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Rev No. 2	
Rev No. 3	
Rev No. 4	
Rev No. 5	
Rev No. 6	
Project Number:	23.20
DWG File	A400.dwg
Designed By:	plan4
Drawn By:	GSC
Approved By:	plan4
Date:	03.25.24

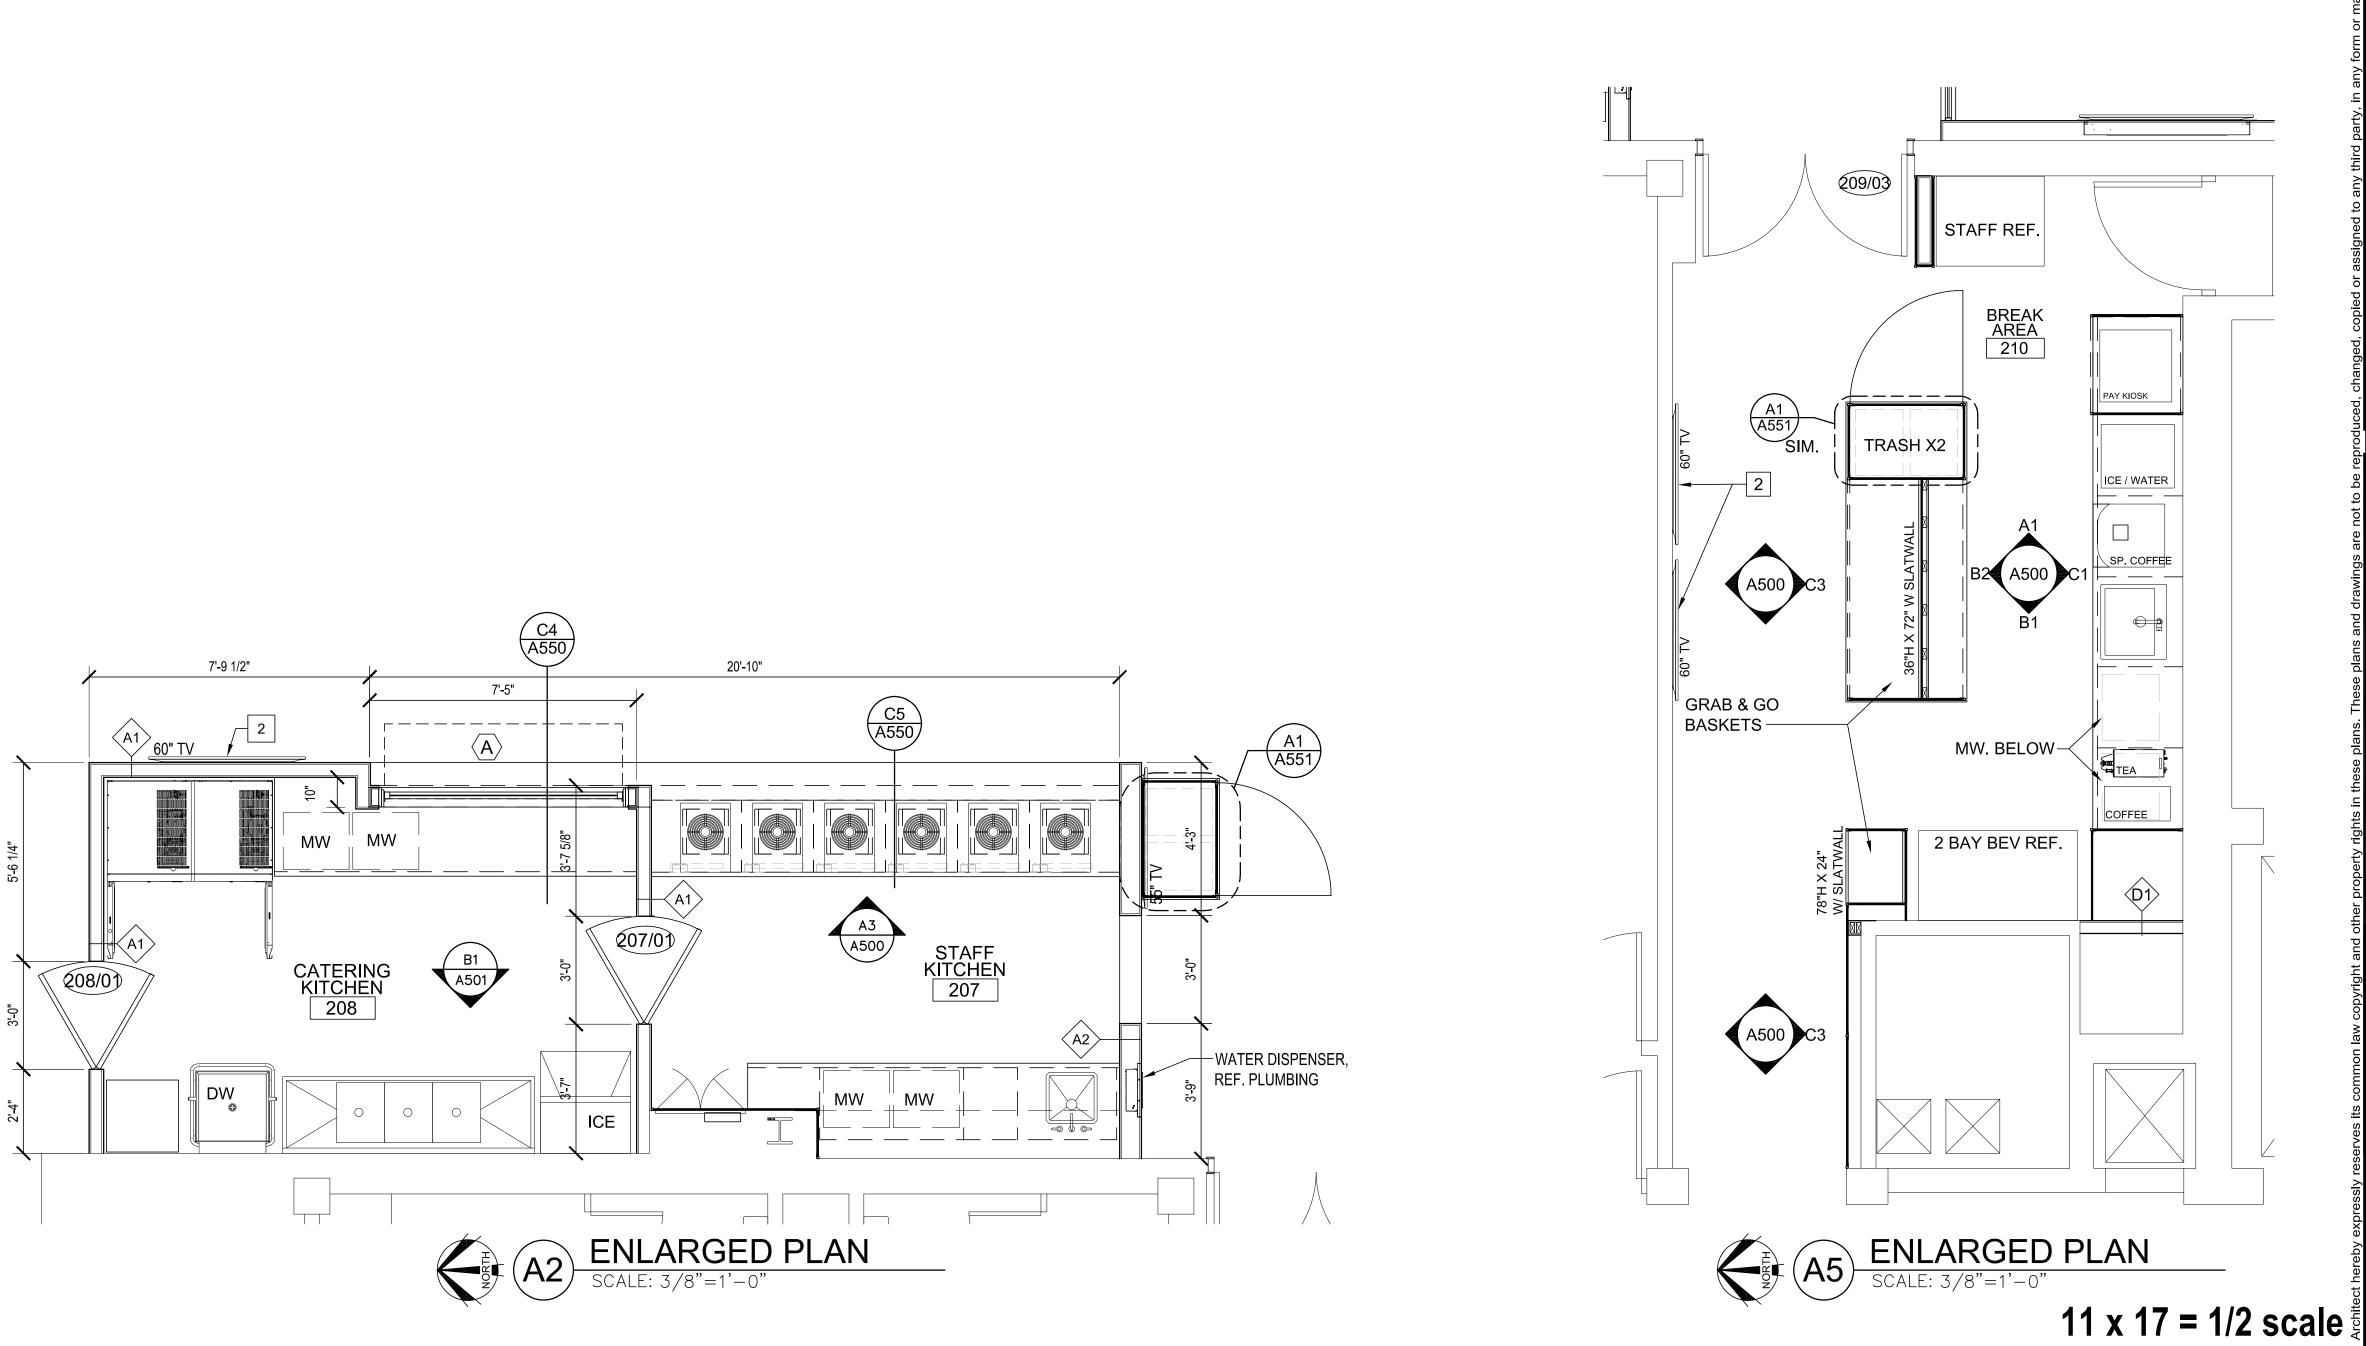

SHEET NUMBER

A40C



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3 north main st., mcpherson kansas 620.241,4353

Farmers Alliance Mutual In 1122 North Main

Contract Date

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Rev No. 4

Rev No. 5

Rev No. 6

Project Number: 23.20

DWG File

Designed By: plan4

Drawn By: GSC


Approved By: plan4


Date: 03.25.24





SHEET NUMBER

A500

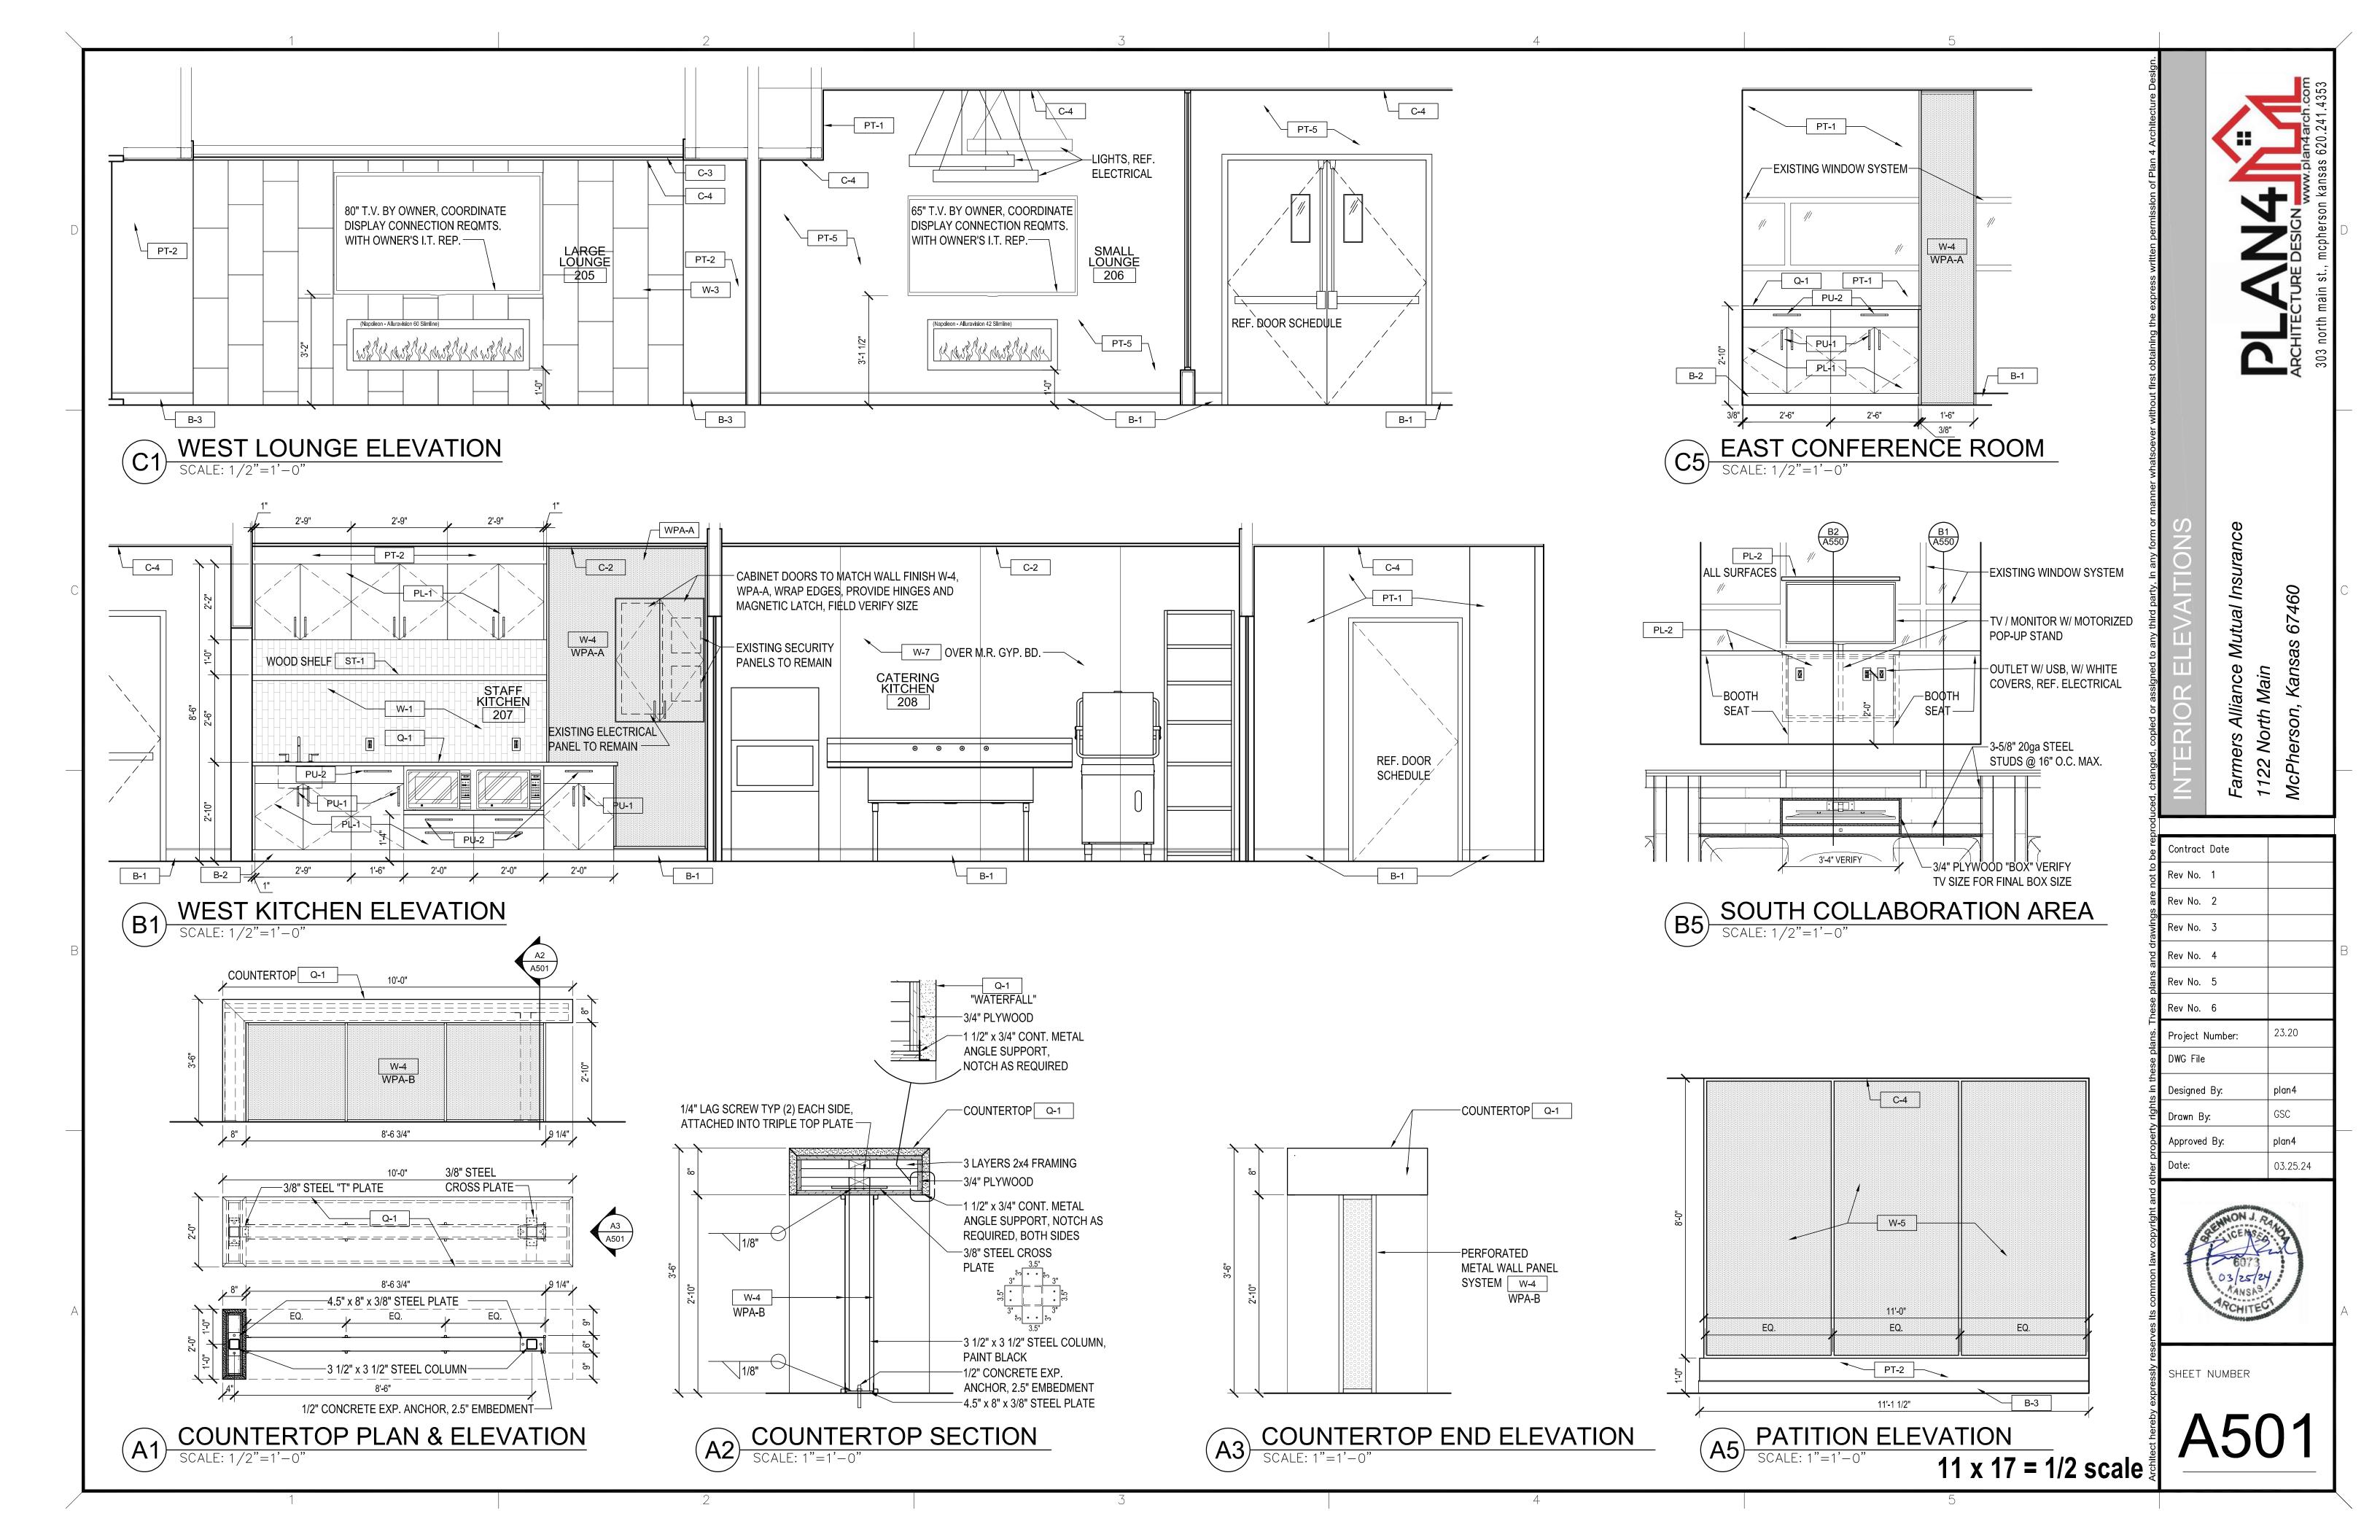

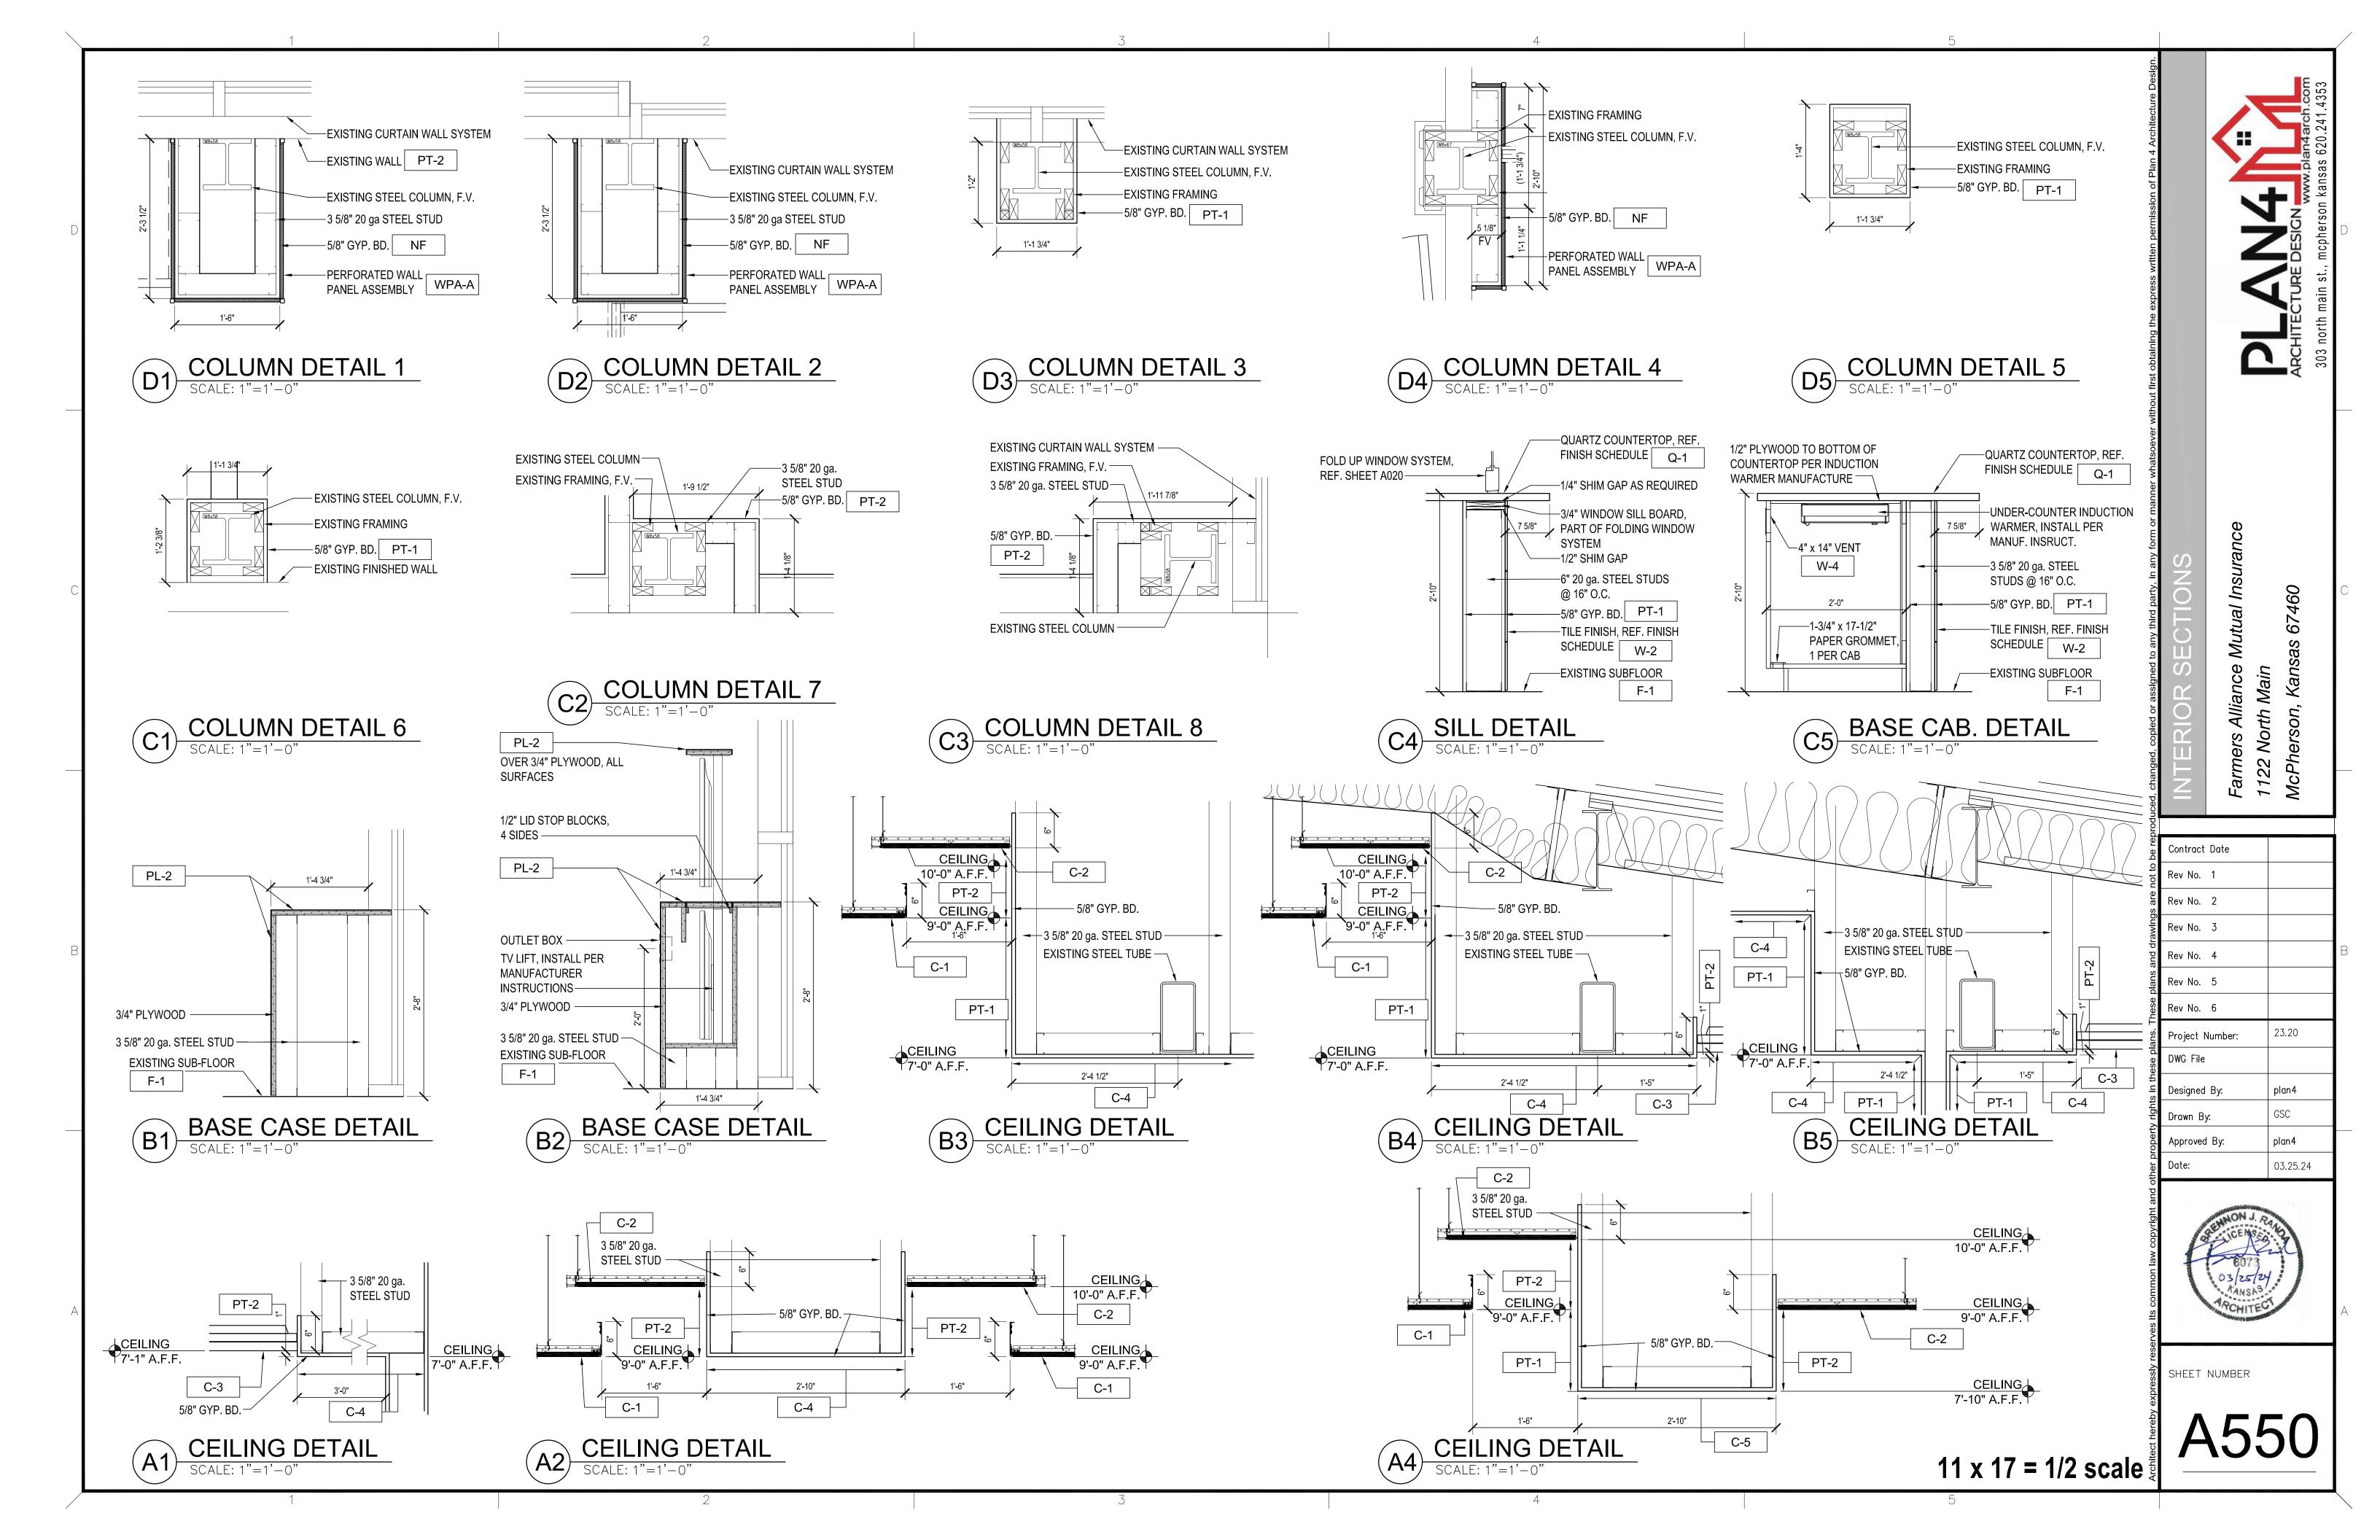

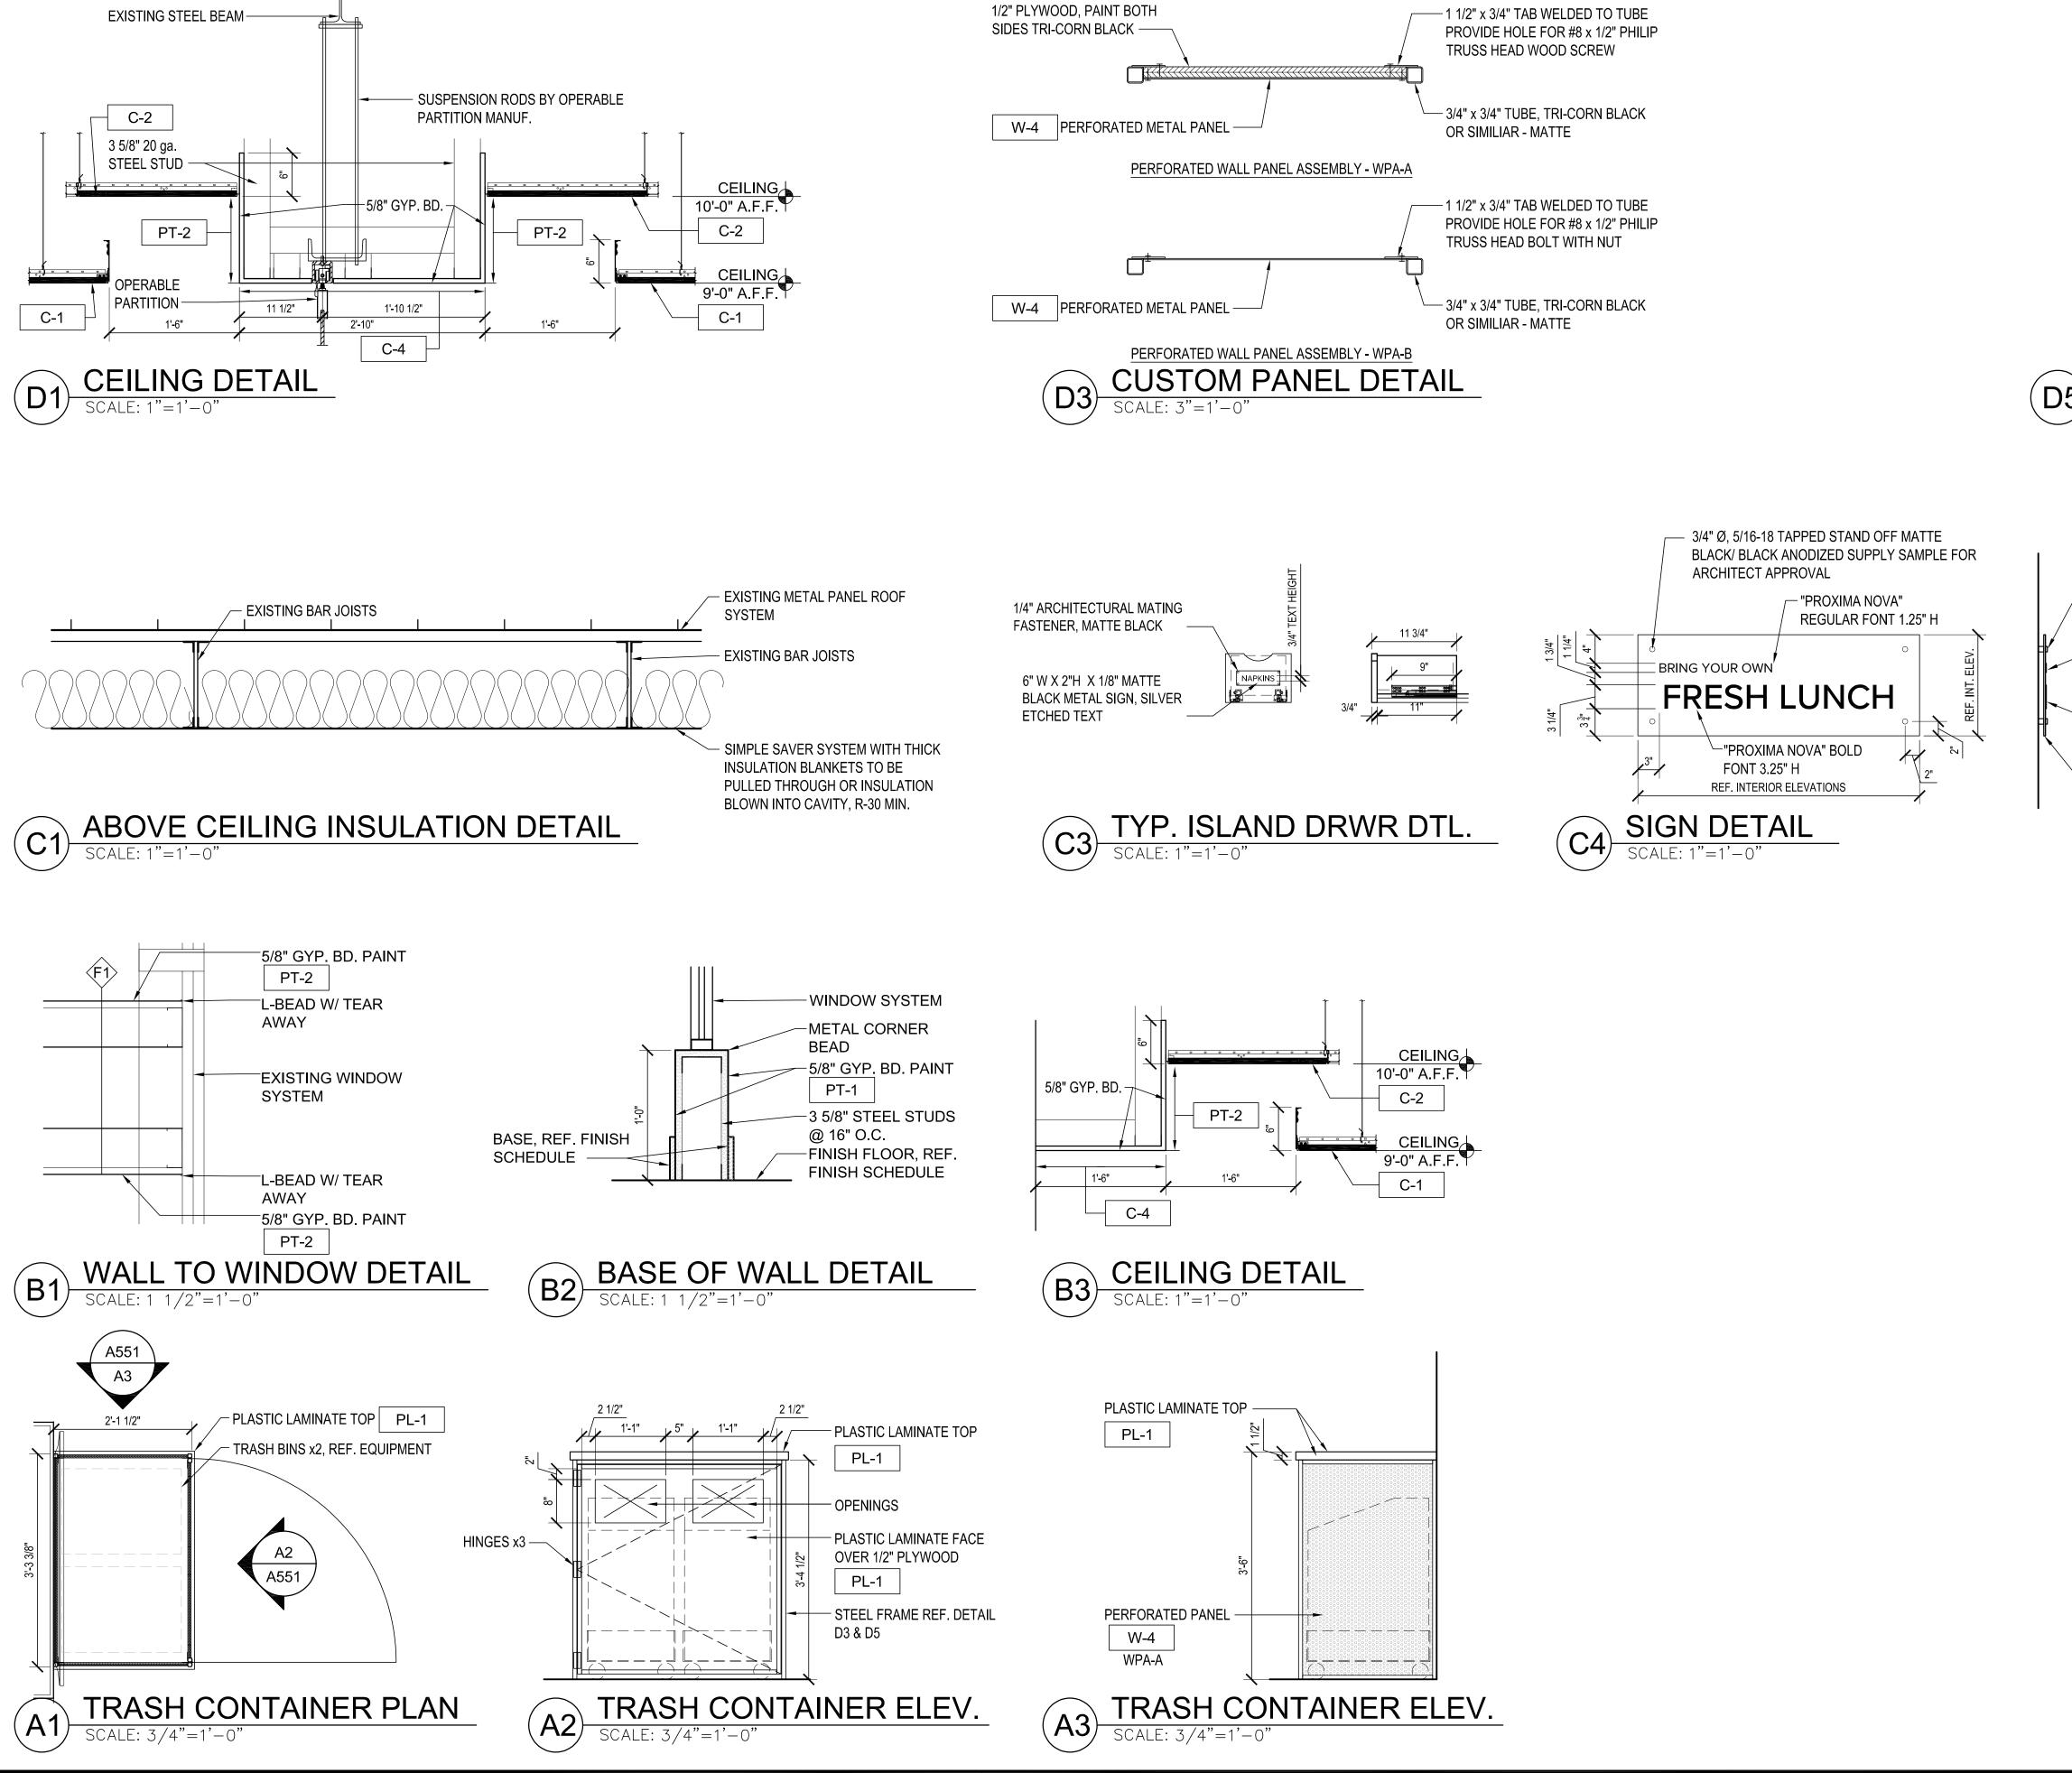

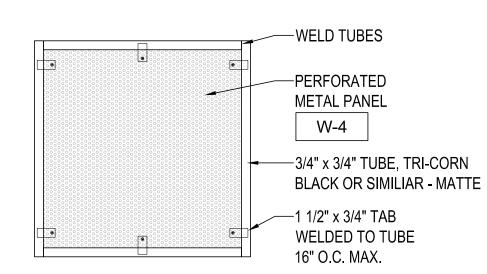

CUSTOM PANEL DETAIL

SCALE: 1 1/2"=1'-0"

3/4" Ø, 5/16-18 TAPPED STAND OFF MATTE BLACK/ BLACK ANODIZED SUPPLY SAMPLE FOR ARCHITECT APPROVAL

1/8" BLACK ACRYLIC, MATTE FINISH, ADHERE TO BACK PANEL, FONT TO BE "PROXIMA NOVA" REGULAR - 1.25" H

1/8" BLACK ACRYLIC, MATTE FINISH, ADHERE TO BACK PANEL, FONT TO BE "PROXIMA NOVA" BOLD - 3.25" H

1/4" BRIGHT WHITE ACRYLIC, MATTE FINISH

JPPLY SAMPLE

FINISH,
ONT TO BE
- 1.25" H
FINISH,
ONT TO BE
5" H

MATTE FINISH

INTERIOR SECTIONS
Farmers Alliance Mutual Insura
1122 North Main


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TAG	FURNITURE TYPE	MANUFACTURER + STYLE	SIZE	FINISH 1	FINISH 2	FINISH (BASE)	QTY
T-1	ROUND CAFÉ TABLE	HAWORTH, JIVE, ROUND, DISC BASE, KNIFE EDGE	29 H X 42 W X 42 L	HPL PLATINUM	PLY-EDGE	CHARCOAL (TR-K)	18
T-2	SM ROUND CAFÉ TABLE	HAWORTH, JIVE, ROUND, DISC BASE, KNIFE EDGE	29 H X 30 W X 30 L	HPL PLATINUM	PLY-EDGE	CHARCOAL (TR-K)	1
T-3	ROUND BAR TABLE	HAWORTH, JIVE, ROUND, DISC BASE, KNIFE EDGE	42 H X 30 W X 30 L	HPL PLATINUM	PLY-EDGE	CHARCOAL (TR-K)	2
T-4	TEAM DINING TABLE, SM	HAWORTH/ CAPPELLINI, BAC RECTANGLE TABLE, SMALL	29 H X 33.5 W X 78.75 L	OAK STAINED ASH (E4-16)	NA	OAK STAINED ASH (E4-16)	1
T-5	TEAM DINING TABLE	HAWORTH/ CAPPELLINI, BAC RECTANGLE TABLE, LARGE	29 H X 33.5 W X 94.5 L	OAK STAINED ASH (E4-16)	NA	OAK STAINED ASH (E4-16)	2
T-6	BOOTH TABLE	HAWORTH, JIVE, DUAL DISC BASE, PEBBLE, GLIDES, KNIFE EDGE	29 H X 42 W X 66 L	HPL LANDMARK WOOD	PLY-EDGE	CHARCOAL (TR-K)	3
T-7	TRAINING ROOM TABLE	HAWORTH, JIVE, C-LEG EXTRUDED, SINGLE CENTERED POWER MODULE, KNIFE EDGE, FLIP, SOFT CASTERS	30 H X 60 W X 29 L	HPL LANDMARK WOOD	PLY-EDGE	CHARCOAL (TR-K)	15
T-7.1	TRAINING ROOM TABLE	HAWORTH, JIVE, QUARTER CONNECTOR	30 H	HPL LANDMARK WOOD	PLY-EDGE	CHARCOAL (TR-K)	4
OT-1	RND. OCCASIONAL TABLE	LELAND FURNITURE, GEMMA OCCASIONAL TABLE, TOTEM BASE, UP EDGE	15 X 32 W X 32 L	OAK	NA	BLACK	1
OT-2	RECT. OCCASIONAL TBL	STEELCASE, BRIGHTON; TABLE, RECTANGLE	16" X 29" X 42"	FAWN CYPRESS HPL	PLATINUM FEET	BLACK FRAME	1
OT-3	RECT. LAPTOP TABLE	HAWORTH, PIP PERSONAL LAPTOP TABLE, SOFT GLIDE	26 X 12.9 W X 21.3 L	WHITE OAK HARDWOOD (VB-W35)	NA	CHARCOAL (TR-K)	8
OT-4	RND LAPTOP TABLE	HIGHTOWER, KONA LAPTOP HEIGHT, ROUND, STD PWDR COAT BASE, PREMIUM LAMINATE TOP	26 X 18.8 W X 18.8 L	LIGHT GRAY SATIN LAMINATE	NA	BLACK POWDER COAT	2
CH-1	CAFÉ CHAIR, ARMLESS	ALLERMUIR, KIN, ARMLESS, UPHOLSTERED SEAT PAD, WOOD LEG	32" SH-17.5" X 18 X 21	BLACK PLASTIC SHELL	DESIGNTEX-IOTA, CHARCOAL	ASH	72
CH-2	CAFÉ CHAIR, ARMS	ALLERMUIR, KIN, SOLID ARM, UPHOLSTERED SEAT PAD, WOOD LEG	32" SH-17.5" X 23.5 X 22	BLACK PLASTIC SHELL	PALLAS - APHRODITE, RED TIDE	ASH	18
CH-3	TRAINING CHAIR	SITONIT, BAJA 4 LEG CHAIR, FIXED ARM, UPHOLSTERED SEAT & BACK, FLOOR SAVER GLIDES, CART	32.5" SH-18" X 27 X 21.5	BLACK PLASTIC SHELL	DESIGNTEX - IOTA, CHARCOAL	BLACK	40
CH-4	SWIVEL CAFÉ CHAIR	HAWORTH, POPPY GUEST WITH WOOD BASE	33" SH-18" X 24.25 X 24.25	MOMENTUM- TWILL EPU, CARBON (FABRIC WILL NEED TESTING)	SMOOTH PLASTER (TR-PLS) TRIM	CLEAR ON WHITE OAK (M5-W35)	2
CH-5	LOUNGE CHAIR	HAWORTH, POPPY LOUNGE WITH BASKET BASE, CONTRASTING UPH	32.6" SH-17.1" X 31 X 29.4	DESIGNTEX - INK, CARBON (BACK)(FABRIC WILL NEED TESTING)	DESIGNTEX-IOTA, OBSIDIAN (SEAT)(FABRIC WILL NEED TESTING)	BLACK (TR-F)	8
CH-6	SWIVEL LOUNGE CHAIR	ARCADIA, DAV HIGH BACK LOUNGE METAL SWIVEL BASE	42.5" X 31.25 X 29.5	CARNEGIE - SILTECH PRESS, 6298-130	PALLAS - APHRODITE, RED TIDE (SEAT)	MATTE BLACK 0605	4
BS-1	BARSTOOL	ALLERMUIR, KIN- LOW BACK STOOL, PLASTIC SHELL, UPHOLSTERED SEAT PAD, WOOD LEGS	34.75" SH 29.25" X 17.5" SW-16.25" X 14"	BLACK PLASTIC SHELL	PALLAS - APHRODITE, RED TIDE (SEAT)	ASH LEGS W/ WHITE ACCENT TRIM	4
L-1	LOUNGE SOFA	HAWORTH/CASSINA, LC5 SOFA	27.8" SH-15" X 100.8" X 30.5"	CF STINSON - STALLION, BLACK BEAUTY (FABRIC WILL NEED TESTING)	NA	BLACK	2
L-2	BOOTH SOFA	HAWORTH, CABANA, 2 SEAT, FULL BACK, SINGLE ARM, 1 POWER + 2 USB, FELT GLIDES	30.5" SH-17.3" X 72" SW-54" X 30" SD-21.125"	CF STINSON - POLYGON, VALENTINE (BACK)	PALLAS - APHRODITE, RED TIDE (SEAT)	BLACK	6
L-3	TRAINING SOFA	DAVIS, MODO BENCH	30.75" SH-19 W X 96" L	DESIGNTEX-IOTA, OBSIDIAN (BACK)	PALLAS - APHRODITE, RED TIDE (SEAT)	05 MATTE BLACK	3
P-1	POUF, SMALL	DAVIS, RHO 119	19" X 19.75" X 19.75"	DESIGNTEX - IOTA, OBSIDIAN	CARDINAL STITCH DETAIL	PLASTIC ADJUSTABLE GLIDES	1
P-2	POUF, SMALL 2	DAVIS, RHO 119	19" X 19.75" X 19.75"	DESIGNTEX - IOTA, POPPY	BLACK STITCH DETAIL	PLASTIC ADJUSTABLE GLIDES	1
P-3	POUF, LARGE	DAVIS, RHO 128	17.5" X 28" X 28"	DESIGNTEX - IOTA, POPPY	BLACK STITCH DETAIL	PLASTIC ADJUSTABLE GLIDES	1
R-1	RUG	MOHAWK GROUP	9' X 10'	UPLIFTING OTHERS	CREATIVE SOUL	ATTACHED NON-SKID BACKING/ BRICK ASHLAR LAYOUT	1
R-2	RUG	MOHAWK GROUP	11' X 13'	URBAN PASSAGE II	METROPOLIS	ATTACHED NON-SKID BACKING	1

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JRNITURE PLAN & SCHEDULE

Contract Date

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Project Number: 23.20

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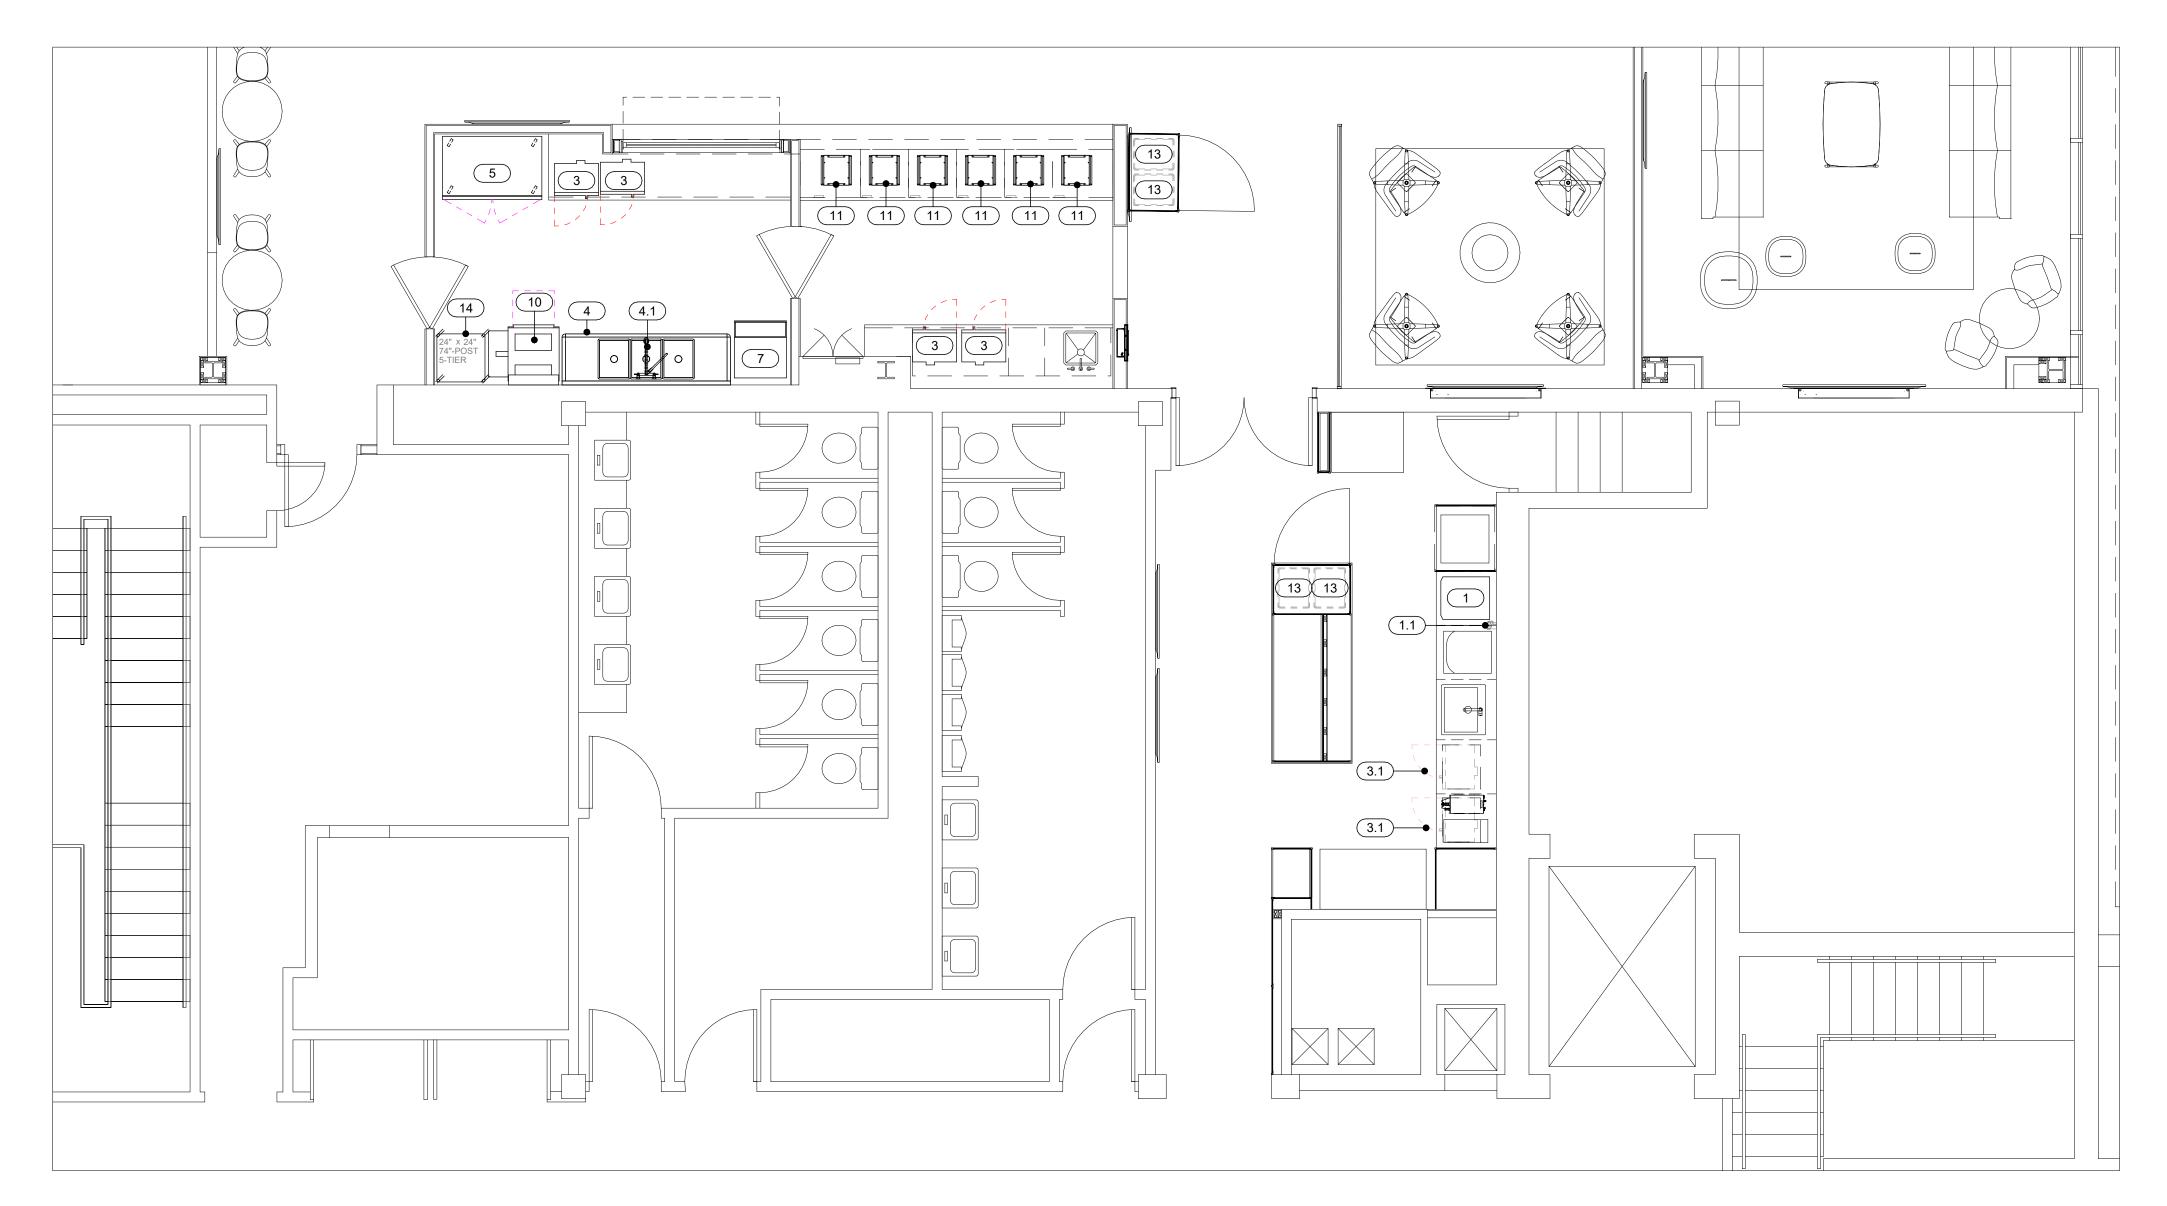
plan4

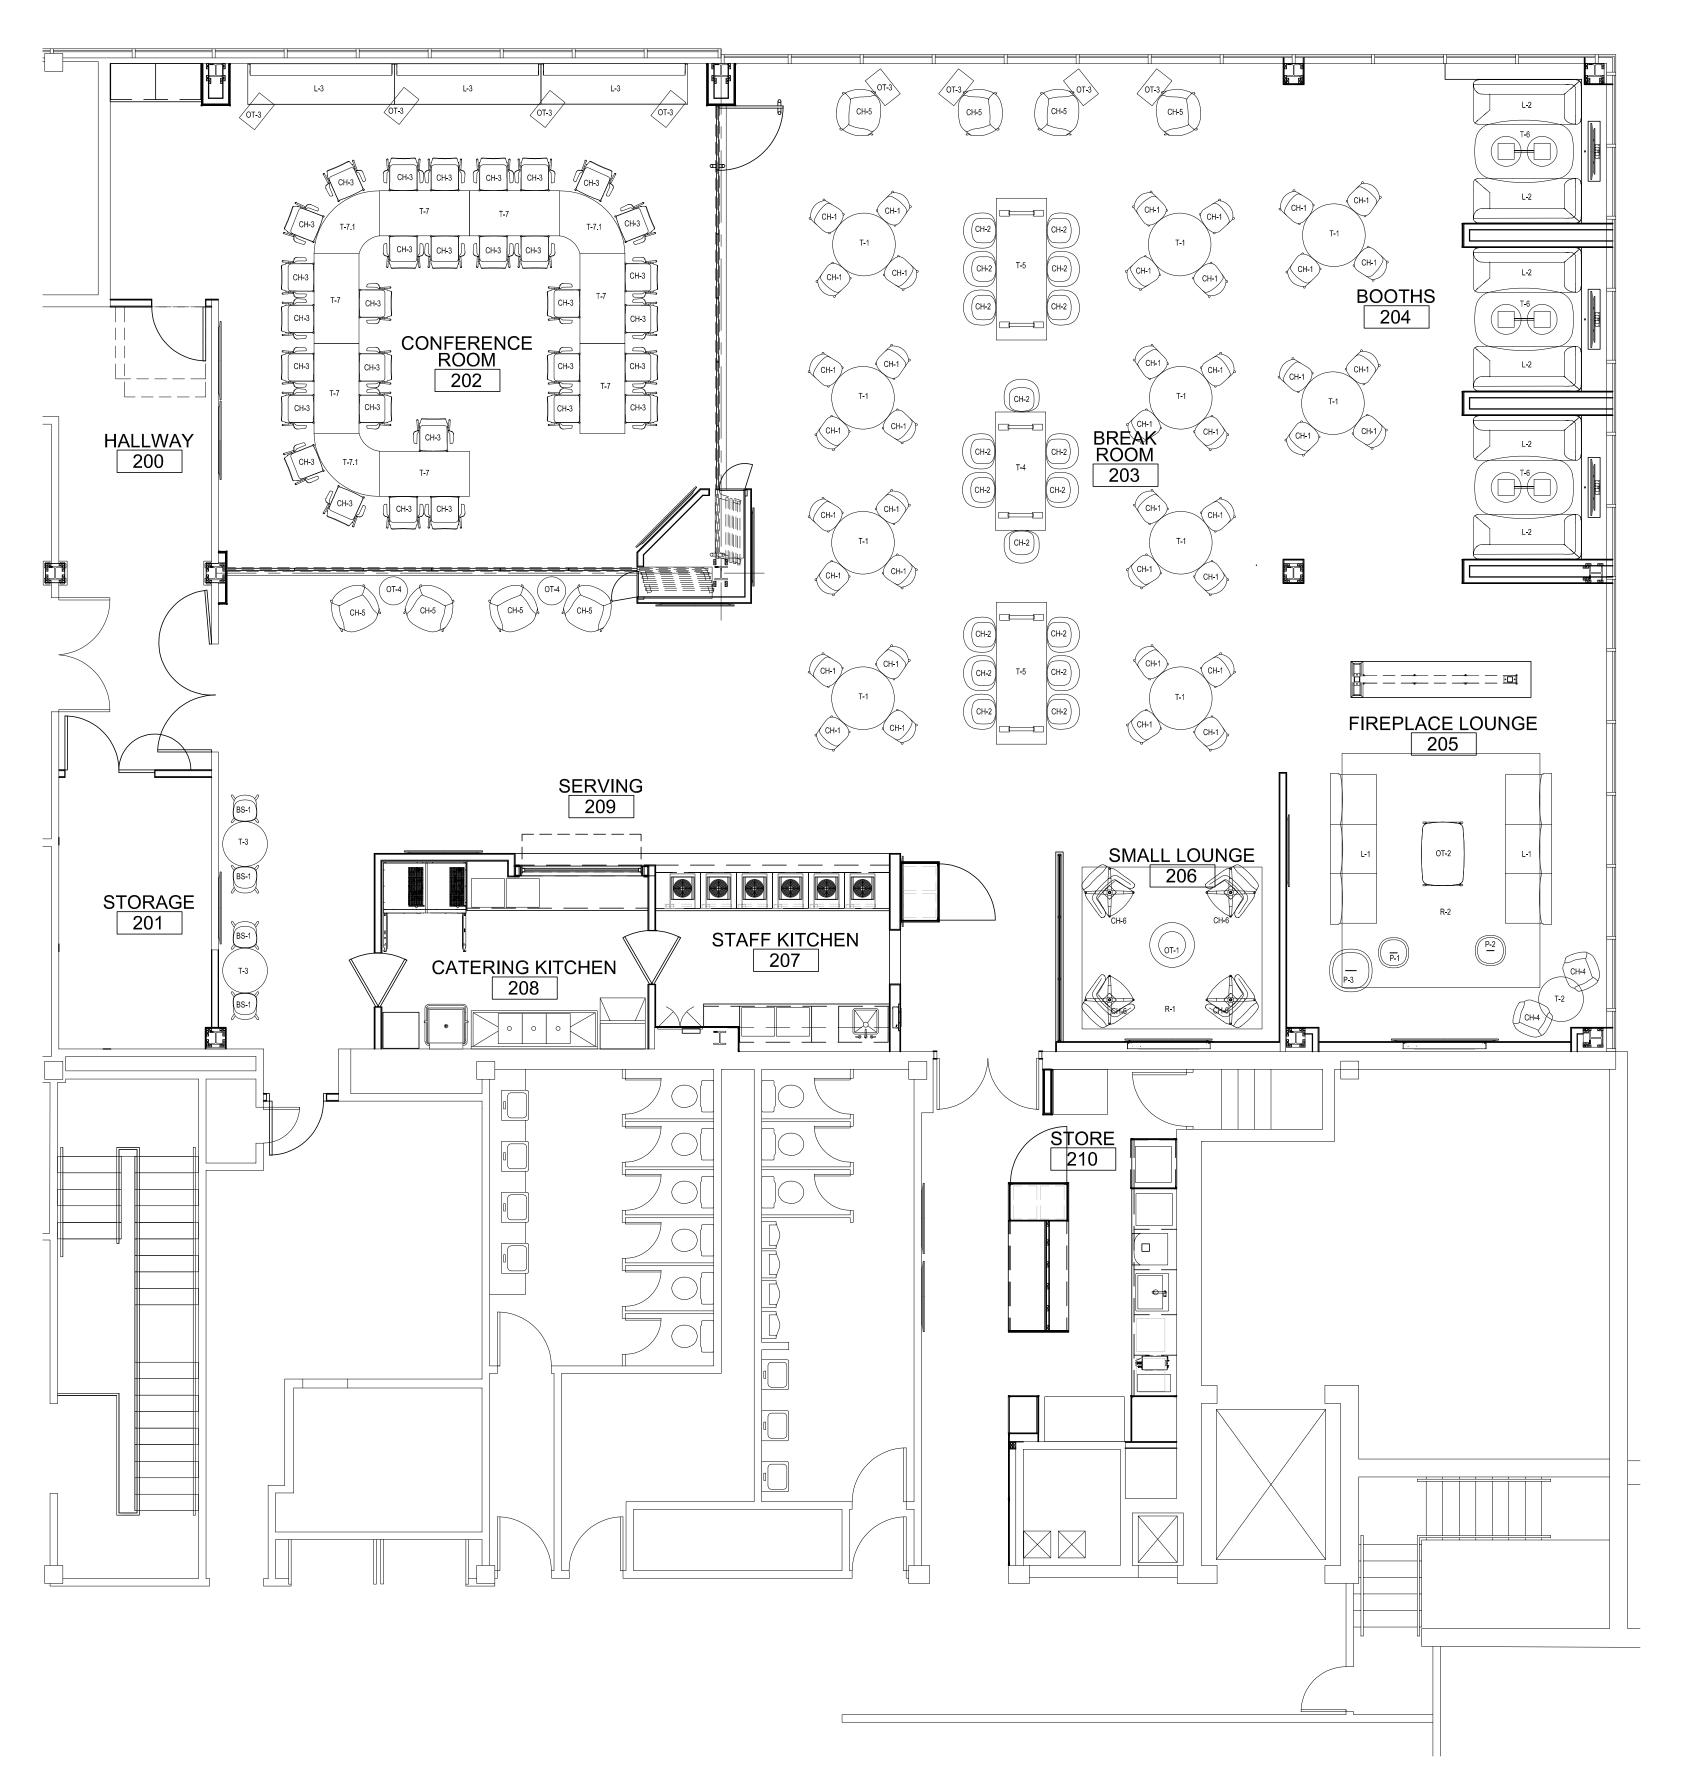SHEET NUMBER

Drawn By:

Approved By:

A600



OVERALL FLOOR PLAN

1/4" = 1'-0"

	FC	DODSERVICE EQUIPMEN	T SCHEDULE
TEM NO.	QTY	DESCRIPTION	REMARKS
1	1	ICE MACHINE/DISPENSER	
1.1	1	WATER FILTER ASSEMBLY	
2	1	SPARE NUMBER	
3	4	MICROWAVE	
3.1	2	MICROWAVE	
4	1	SINK, 3 COMPARTMENT	
4.1	1	PRE RINSE FAUCET	
5	1	UPRIGHT REACH-IN DUAL TEMPS	
6	1	SPARE NUMBER	
7	1	ICE MAKER, UNDERCOUNTER	BY OTHERS
8	1	SPARE NUMBER	
9	1	SPARE NUMBER	
10	1	HIGH TEMPERATURE DISHWASHER	
11	6	INDUCTION WARMER	
12	1	SPARE NUMBER	
13	4	TRASH CANS	
14	1	WIRE SHELVING UNIT, DRY STORAGE	



1647 Sunflower Road PO Box 1277 Salina, KS 67402-1277 Ph. 785-823-5512 sunflowersrs.com

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Revision Schedule								
Date	Number	Description						

1122 NORTH MAIN MCPHERSON, KS 67460

PROJECT 23015

02.23.2024


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TUAL INSURANCE

SDS

FOODSERVICE EQUIPMENT PLAN

K-100

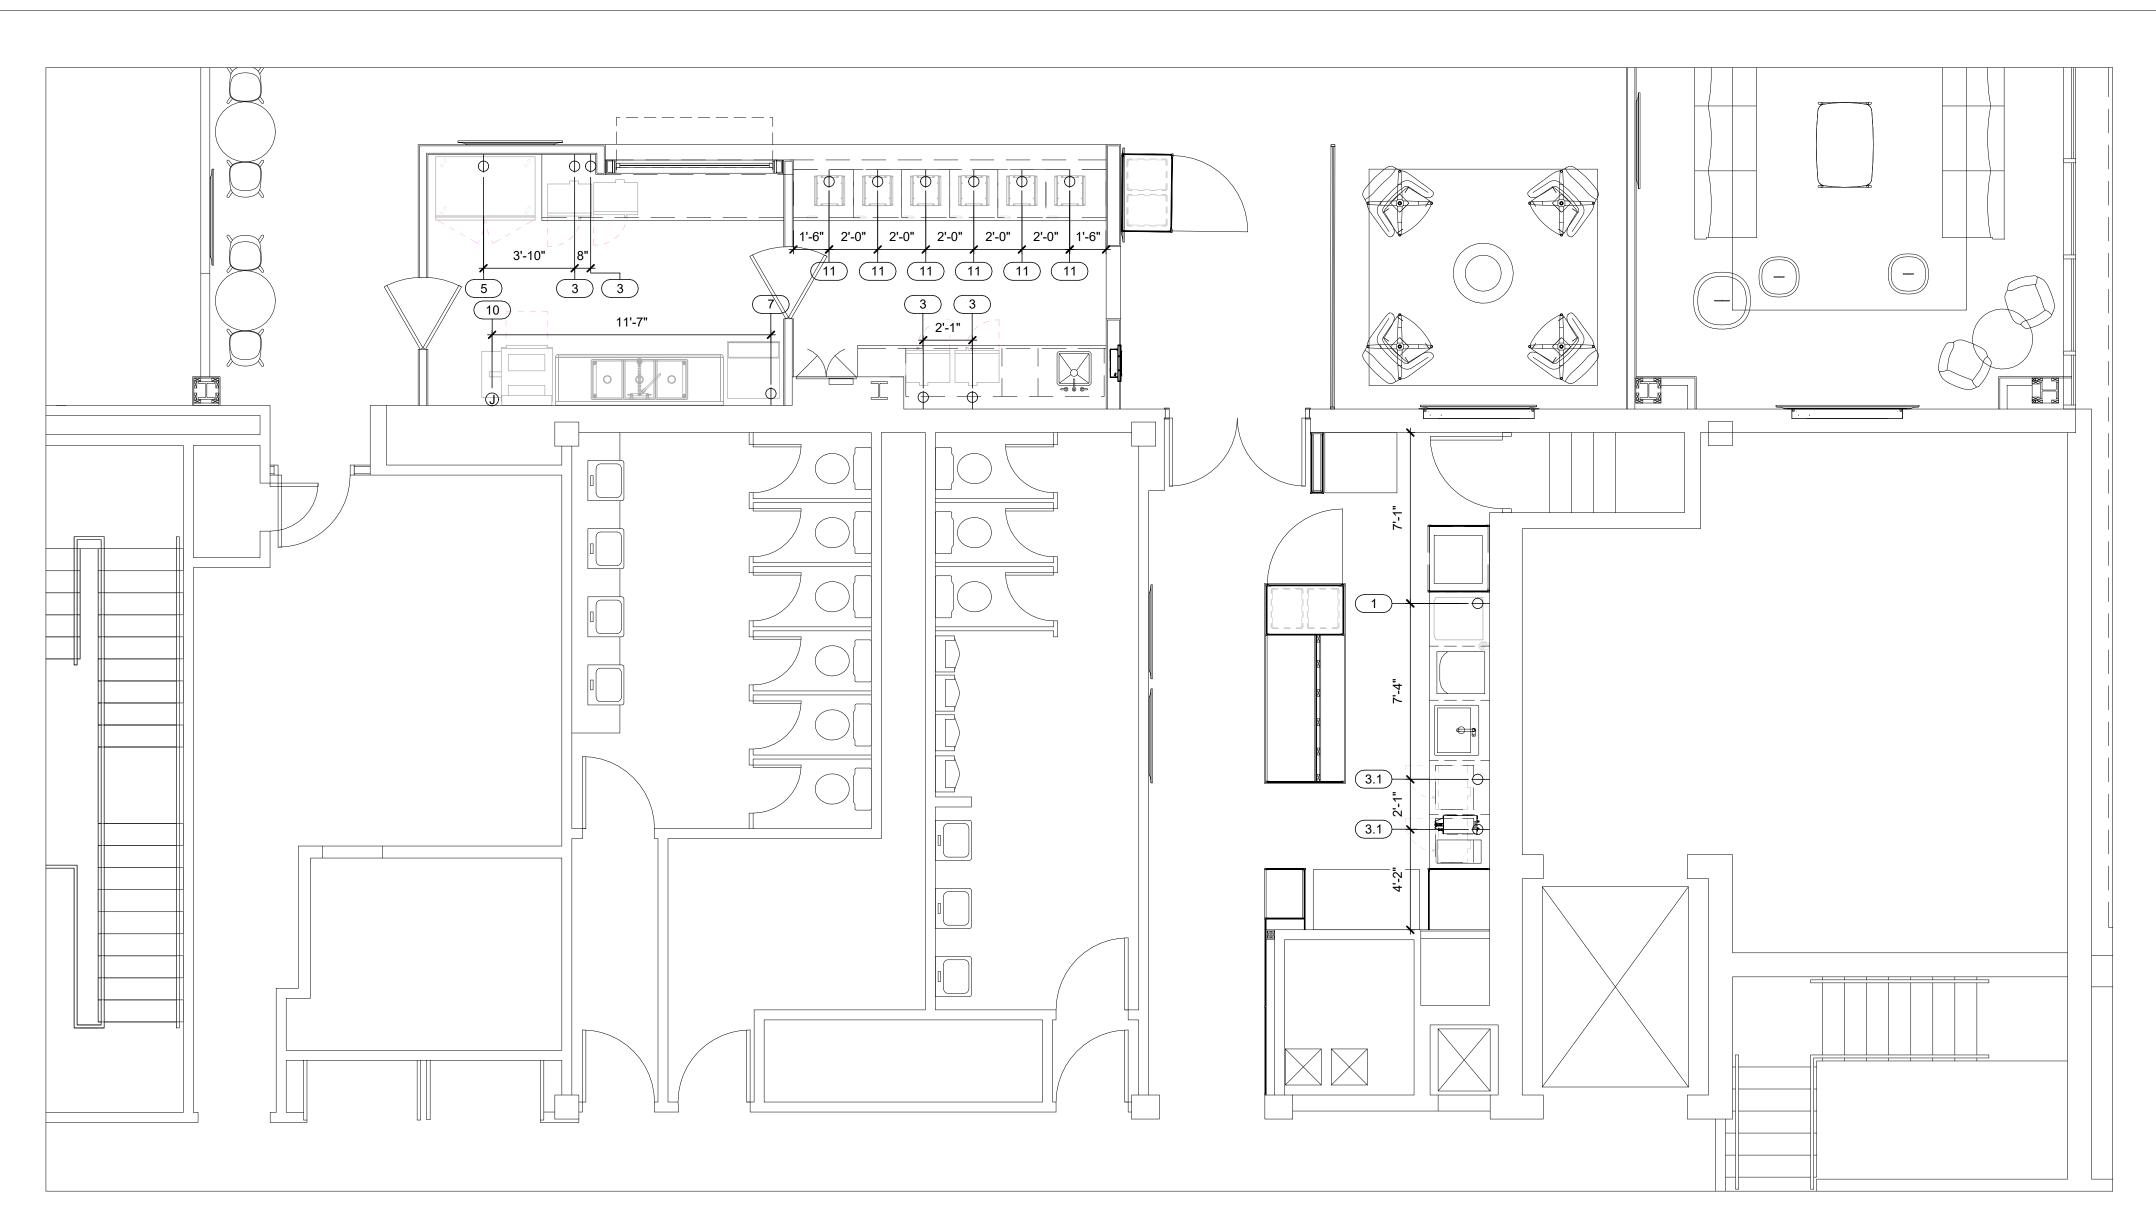

ELECTRICAL ROUGH-IN PLAN

1/4" = 1'-0"

		FOODSERV	ICE EL	LEC	ΓRICA	L SCH	EDU	LE
			ELI	ROUGH-IN / CONNECTION		-		
ITEM							HGT	
NO.	QTY	DESCRIPTION	VOLTS	PH	AMPS	TYPE	AFF	REMARKS
1	1	ICE MACHINE/DISPENSER	120	1	15.00	SR	42"	
3	4	MICROWAVE	120	1	13.00	SR	42"	
3.1	2	MICROWAVE	120	1	13.00	SR	24"	
5	1	UPRIGHT REACH-IN DUAL TEMPS	120	1	9.00	SR	72"	
7	1	ICE MAKER, UNDERCOUNTER	120	1	7.00	SR	24"	BY OTHERS, VERIFY REQUIREMENTS
10	1	HIGH TEMPERATURE DISHWASHER	208	1	78.00	JB	60"	
11	6	INDUCTION WARMER	120	1	5.00	SR	24"	

ELECTRICAL LEGEND

	DUPLEX RECEPTACLE
₩ ₩	WEATHERPROOF RECEPTACLE
	SINGLE RECEPTACLE
0	SPECIAL PURPOSE RECEPTACLE
	QUAD RECEPTACLE
\bigcirc	FLUSH FLOOR MOUNT RECEPTACLE
	JUNCTION BOX
S	SWITCH
	DATA CONNECTION
F	MANUAL FIRE PULL STATION
	DROP CORD MOUNTED FROM CEILING

CONDUIT STUB LOCATION

DEFROST TIME CLOCK

□ DISCONNECT

LIGHT - RECTANGULAR

LIGHT - ROUND

MOTOR

EXHAUST HOOD SENSOR

^ TEMPERATURE 05N005

○_{TEMP} TEMPERATURE SENSOR

PLUG MOLD

SUNFLOWER Restaurant Supply, Co. A DIVISION OF CASH-WA DISTRIBUTING

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Revision Schedule							
Date	Number	Description					
		·					

FARMER'S ALLIANCE MUTUAL INSURANCE 1122 NORTH MAIN MCPHERSON, KS 67460

PROJECT 23015


02.23.2024

SDS

SDS

FOODSERVICE ELECTRICAL ROUGH-IN PLAN

K-200

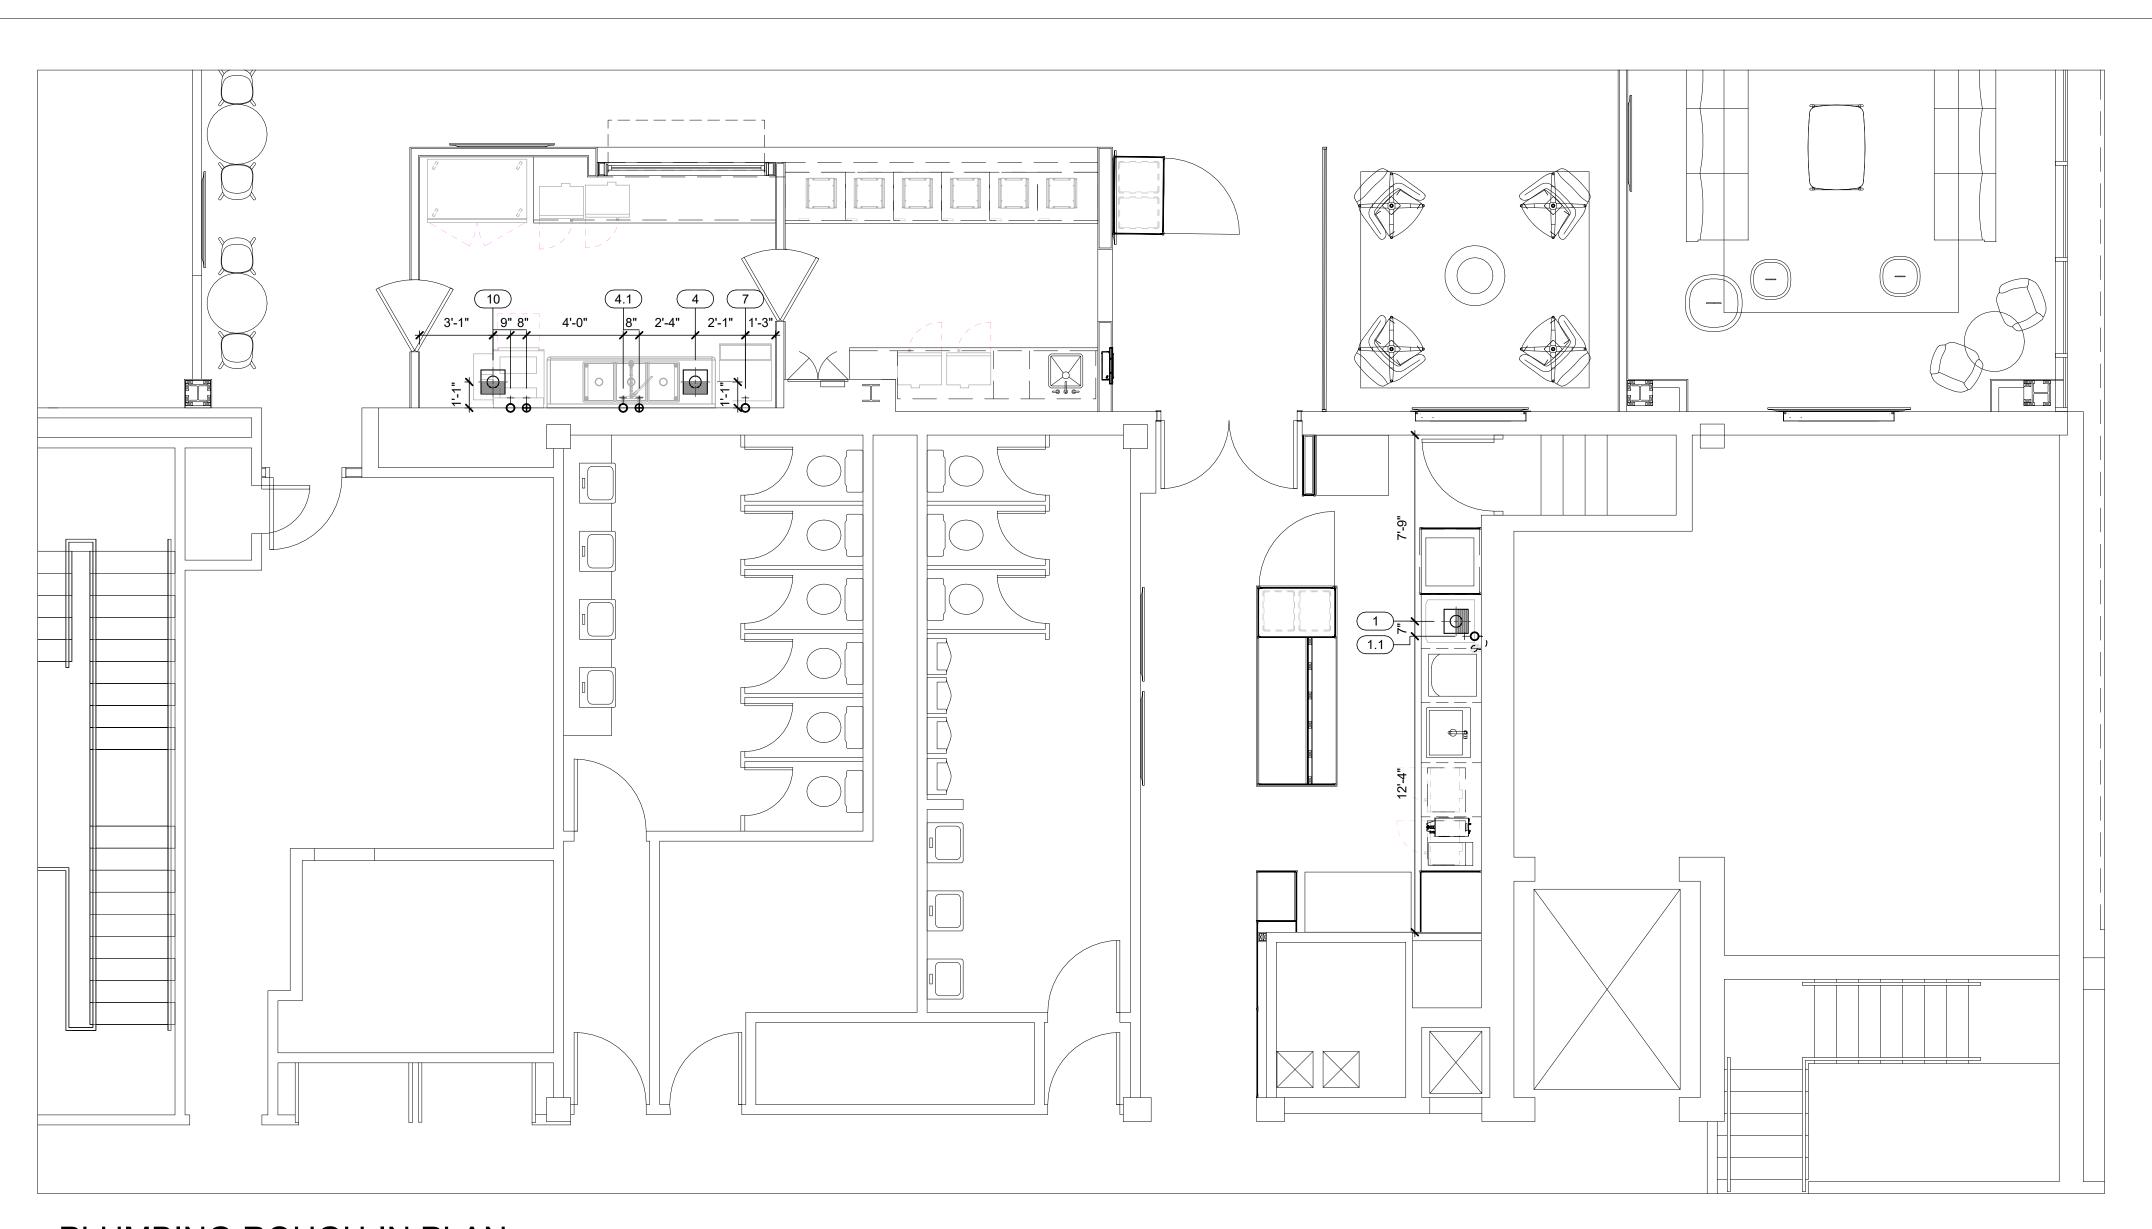

PLUMBING ROUGH-IN PLAN

1/4" = 1'-0"

						FOO	DSEF	RVICE	PLU	MBIN	G S	CHEDULE
					WAT	ΓER		WASTE		GAS		
ITEM			Н	ОТ	COL	D F	ILTERED	DIRECT				
NO.	QTY	DESCRIPTION	SIZE	AFF	SIZE	AFF S	SIZE AFF	SIZE AFF	SIZE	MBTU	AFF	REMARKS
1	1	ICE MACHINE/DISPENSER				3	3/8" 16"					IW; PC TO RUN INDIRECT WASTE TO FLOOR SINK, PC TO EXTEND CW THROUGH WATER FILTER
1.1	1	WATER FILTER ASSEMBLY			3/8"	16"						PC TO EXTEND TO DISPENSER
4	1	SINK, 3 COMPARTMENT										IW; PC TO RUN INDIRECT WASTE TO FLOOR SINK
4.1	1	PRE RINSE FAUCET	1/2"	16"	1/2"	16"						
7	1	ICE MAKER, UNDERCOUNTER			3/8"	16"						BY OTHERS - IW; PC TO RUN INDIRECT WASTE TO FLOOR SINK
10	1	HIGH TEMPERATURE DISHWASHER	1/2"	60"	1/2"	16"						IW: PC TO BLIN INDIRECT WASTE TO ELOOR SINK

PLUMBING LEGEND

- HOT WATER
- SOFTENED HOT WATER
- COLD WATER
- SOFTENED COLD WATER
- FILTERED WATER
- DIRECT WASTE
- FLOOR DRAIN
- FLOOR SINK THREE-QUARTER GRATE
- FLOOR SINK PARTIAL GRATE
- FLOOR SINK NO GRATE
- FUNNEL FLOOR DRAIN
- HUB FLOOR DRAIN
- AREA FLOOR DRAIN SLOPED PER CODE
- GAS DROP FROM MANIFOLD
- FIRE SUPPRESSION GAS SHUT-OFF VALVE
- ++ CS CHILLED WATER
- CHILLED WATER RETURN
- ⇒ss STEAM SUPPLY
- \oplus CRCONDENSATE RETURN



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1122 NORTH MAIN MCPHERSON, KS 67460

PROJECT 23015

02.23.2024

SDS

INSURANCE

SDS

FOODSERVICE PLUMBING ROUGH-IN PLAN

K-300

PROJECT GENERAL NOTES

- ALL WORK PERFORMED SHALL COMPLY WITH CURRENT FEDERAL, STATE AND LOCAL CODES AND ORDINANCES.
- CONTRACTOR SHALL REPORT ANY CONFLICTS TO THE ENGINEER IMMEDIATELY.
- CONTRACTOR SHALL REVIEW THE DRAWINGS AND SPECIFICATIONS PRIOR TO BIDDING JOB AND DURING CONSTRUCTION. DRAWINGS ARE DIAGRAMMATIC IN NATURE AND SHOW THE GENERAL INSTALLATION OF EQUIPMENT & MATERIALS IN RELATIONSHIP TO STRUCTURE & OTHER TRADES. DRAWINGS MAY NOT INDICATE EVERY REQUIRED OFFSET, FITTING, ETC. FIELD VERIFY ACTUAL JOB CONDITIONS AND COORDINATE WORK WITH OTHER TRADES PRIOR TO BIDDING JOB, ORDERING EQUIPMENT, FABRICATION OF MATERIALS, OR STARTING WORK.
- PROVIDE EQUIPMENT, MATERIALS, & LABOR FOR A COMPLETE PROJECT AS SHOWN IN THE DRAWINGS AND SPECIFICATIONS. CHANGE ORDERS WILL NOT BE GRANTED DUE TO LACK OF COORDINATION WITH OTHER TRADES & JOB
- IF EQUIPMENT, MATERIALS, ETC. OTHER THAN THOSE SCHEDULED & SPECIFIED ARE FURNISHED, IT IS THE RESPONSIBILITY OF THE CONTRACTOR TO COORDINATE ALL ITEMS THAT AFFECT OTHER DISCIPLINES WITH THE CORRESPONDING CONTRACTOR AND THE GENERAL CONTRACTOR, ADDITIONAL FUNDING FOR DEVIATIONS WILL NOT BE ALLOWED.
- MAINTAIN ALL REQUIRED CLEARANCES FOR NEW AND/OR EXISTING EQUIPMENT, FRESH AIR OPENINGS, EXHAUST/VENT OPENINGS, AND COMBUSTION OPENINGS.
- THE GC SHALL CUT/PATCH FLOORS, WALLS, CEILINGS, & ROOFS AS REQUIRED FOR INSTALLATION/DEMOLITION OF MECHANICAL AND PLUMBING SYSTEMS CONVEYED IN THESE DRAWINGS. COORDINATE WITH GC.
- THE CONTRACTOR SHALL BE RESPONSIBLE FOR STORAGE OF EQUIPMENT AND MATERIALS DURING CONSTRUCTION. ITEMS DAMAGED DURING CONSTRUCTION SHALL BE REPLACED AT THE CONTRACTOR'S EXPENSE. UPON COMPLETION OF THE PROJECT THE CONTRACTOR SHALL PROVIDE AS-BUILT DRAWINGS TO THE OWNER, ARCHITECT, AND ENGINEER SHOWING EQUIPMENT, DUCTWORK, PIPING, ETC. THAT DIFFERS FROM CONSTRUCTION
- DOCUMENTS AS THEY ARE ACTUALLY INSTALLED. AS-BUILT DRAWINGS ARE TO BE READILY AVAILABLE ON SITE AND ALL CHANGES ARE TO BE DOCUMENTED IMMEDIATELY. THE RESPONSIBILITY OF EACH CONTRACTOR IS NOT LIMITED TO THEIR SPECIFIC DISCIPLINE'S DRAWING SHEETS. REFER TO OTHER DISCIPLINES' DRAWING SHEETS AS REQUIRED FOR ADDITIONAL INFORMATION/INSTRUCTIONS.
- FIRE SEAL ALL PENETRATIONS THRU RATED ASSEMBLIES WITH APPROPRIATE SLEEVE / PROTECTION MATERIAL. UNLESS NOTED OTHERWISE, SCHEDULED OR INDICATED AIRFLOWS ARE CUBIC FEET PER MINUTE (CFM), WATER FLOWS ARE GALLONS PER MINUTE (GPM), AIR PRESSURE DROPS AND STATIC PRESSURES ARE INCHES OF WATER
- COLUMN ("W.C.), AIR VELOCITIES ARE FEET PER MINUTE (FPM), WATER PRESSURE DROPS AND PUMP HEADS ARE FEET OF WATER COLUMN (FT. HD.), WATER VELOCITIES ARE FEET PER SECOND (FPS), CAPACITIES ARE THOUSANDS BTU/H (MBH), TEMPERATURES ARE °F, WEIGHTS ARE POUNDS (LB.), AREAS ARE SQUARE FEET (SQ. FT.), VOLUMES ARE GALLONS (GAL.), SOUND POWER LEVELS ARE DECIBELS (DB).
- REMOVE ALL SUPPORTS, HANGARS, ACCESSORIES, ETC. ASSOCIATED WITH PIPING, DUCTWORK, EQUIPMENT, ETC. INDICATED TO BE DEMOLISHED UNLESS NOTED OTHERWISE
- 14. DO NOT ROUTE DUCTWORK OR PIPING ABOVE ELECTRICAL PANELS OR ELECTRICAL GEAR. 15. ALL EXTERIOR WALL AND/OR ROOF PENETRATIONS ARE TO BE SEALED WEATHERTIGHT.
- 16. PROVIDE AND INSTALL SUPPLEMENTAL STEEL FRAMING AS REQUIRED FOR SUPPORT OF SYSTEM COMPONENTS.
- 17. SUPPORT ALL PIPING AND DUCTWORK INDEPENDENTLY FROM ASSOCIATED EQUIPMENT, SO NO GRAVITY LOAD IS ON UNIT CONNECTIONS.

PROJECT MECHANICAL NOTES

- COORDINATE INSTALLATION OF MECHANICAL SYSTEMS WITH OTHER TRADES TO ENSURE NEAT AND ORDERLY INSTALLATION.
- FIELD MEASURE FINAL DUCTWORK AND PIPING LOCATIONS PRIOR TO FABRICATION AND MAKE ADJUSTMENTS AS REQUIRED. ADJUST LOCATION OF CEILING DIFFUSERS, REGISTERS AND GRILLES AS REQUIRED TO ACCOMMODATE FINAL CEILING GRID, STRUCTURE, AND LIGHTING LOCATIONS.
- COORDINATE ACCESS TO EQUIPMENT, VALVES, AND DAMPERS INSTALLED ABOVE 'INACCESSIBLE' CEILINGS AND IN CHASES, ETC. WITH GC. GC SHALL PROVIDE AND INSTALL ACCESS DOORS FOR EQUIPMENT SERVICE, DAMPERS AND / OR
- A MAXIMUM LENGTH OF 5'-0" FLEX DUCT MAY BE USED AT EACH RUNOUT TO SUPPLY DIFFUSERS. FLEX DUCT SHALL ONLY BE USED ABOVE LAY-IN CEILINGS AND IN CONCEALED LOCATIONS, AND SHALL NOT BE USED IN RETURN OR
- DUCT SIZES INDICATED ARE INSIDE CLEAR DIMENSIONS.
- INSTALL MANUAL BALANCING DAMPER IN DUCT RUNOUTS TO AIR DEVICES WITH AIRFLOW INDICATED IN TAG, UNLESS DEVICE IS SCHEDULED TO BE PROVIDED WITH OPPOSED BLADE DAMPER. THIS INCLUDES AT EQUIPMENT SERVING ONE
- THERMOSTATS SHALL BE PLACED AT 4'-0" MAXIMUM ABOVE FINISHED FLOOR TO MEET ADA REQUIREMENTS.
- PROVIDE FLEXIBLE CONNECTION AT ALL DUCT CONNECTIONS TO EQUIPMENT.
- 10. ROOF EQUIPMENT CURB HEIGHTS SHALL BE SELECTED TO ALLOW 8" (MIN) BETWEEN BOTTOM OF EQUIPMENT AND ROOF SURFACE.
- 11. ALL FILTERS SHALL BE NEW AT PROJECT TURNOVER, AND ONE (1) SET OF SPARE FILTERS FOR ALL EQUIPMENT SHALL BE PROVIDED TO THE OWNER.

PROJECT PLUMBING NOTES

- COORDINATE INSTALLATION OF PLUMBING SYSTEMS WITH OTHER TRADES TO ENSURE NEAT AND ORDERLY INSTALLATION.
- FIELD MEASURE FINAL PIPING LOCATIONS PRIOR TO FABRICATION AND MAKE ADJUSTMENTS AS REQUIRED. COORDINATE ROUTING OF PLUMBING AND PIPING WITH DUCTWORK, LIGHTS, ARCHITECTURAL CEILING AND STRUCTURAL ELEMENTS. DUCTWORK SHALL TAKE PRECEDENCE OVER ALL PIPING, EXCEPT WHERE GRADE MUST BE
- MAINTAINED FOR DRAINAGE.
- NO PIPING SHALL PENETRATE STRUCTURAL MEMBERS. PROVIDE WCO AT BASE OF ALL WASTE STACKS INCLUDING LAVATORIES AND SINKS.
- THE CONTRACTOR SHALL VERIFY ALL EXISTING CONDITIONS OF SANITARY SEWER / WATER / GAS SERVICES. COORDINATE WITH LOCAL UTILITIES AND AUTHORITIES WHERE REQUIRED.
- REFER TO PLUMBING FIXTURE SCHEDULE FOR PIPING RUN-OUT SIZES TO EACH INDIVIDUAL PLUMBING FIXTURE. CONTRACTOR SHALL VERIFY ALL CONNECTION REQUIREMENTS TO EQUIPMENT PROVIDED BY OTHERS.
- UTILIZE LONG RADIUS SANITARY PATTERN FITTINGS FOR ALL CHANGES IN DIRECTION IN CONDENSATE DRAIN PIPING. PROVIDE CLEANOUT AT EACH 135° CHANGE IN DIRECTION.
- 10. PROVIDE TRAP GUARD DIAPHRAGM AT EACH FLOOR DRAIN, FLOOR SINK, AND TRENCH DRAIN, UNLESS NOTED OTHERWISE,
- 11. ALL PVC PIPING/DUCTING SHALL BE SOLID CORE.

SYMBOLS

		HVAC DL	JCTWOR	K	
		& ACCES	SORIE	S	
SYMBOL	ABBR	DESCRIPTION	SYMBOL	ABBR	DESCRIPTION
		NEW DUCTWORK			45° TAKEOFF FITTING WITH MANUAL VOLUM
		EXISTING DUCTWORK			DAMPER
23		EXISTING DUCTWORK TO BE REMOVED			MANUAL VOLUM DAMPER
		RECTANGLE DUCT UP		М	MOTORIZED DAMPER
		RECTANGLE DUCT DOWN		FD	FIRE DAMPER
		RECTANGULAR VANED ELBOW	(S)	FS	COMBINATION FIRE/SMOKE DAMPER
$\blacksquare \boxtimes$		ROUND DUCT UP			SMOKE
$\prod \bigotimes$		ROUND DUCT DOWN		S	DAMPER
		ROUND ELBOW			
		CONCENTRIC TRANSITION			

TRANSITION **ECCENTRIC**

TRANSISTION

SQUARE TO

ROUND

DUCT DROP/RISE

IN DIRECTION OF

ARROW

DIFFUSER

RETURN / EXHAUST AIR GRILLE ARROW INDICATE

THROW DIRECTION

		FIF			
SYMBOL	ABBR	DESCRIPTION	SYMBOL	ABBR	DESCRIPTION
~~~~	W	SANITARY WASTE	О		ELBOW UP
•••	'	BELOW FLOOR	CH		ELBOW DOWN
<b>—</b> GW <b>—</b>	GW	GREASE WASTE	Юн		TEE UP
► MUD/OIL→		MUD OR OIL	H		TEE DOWN
<b></b>	V	SANITARY VENT	·		PIPE CAP OR PLUG
<b>—</b> CD <b>—</b>	CD	CONDENSATE DRAIN	<b>├</b> ──ठि—		BALL VALVE
<b>—</b> RD <b>→</b>	RD	ROOF DRAIN	<b>⊢</b> ⊢⊢		BUTTERFLY VALVE
—ORD—	ORD	ROOF OVERFLOW	<b>⊢</b> —₩ <b>—</b> →		GATE VALVE
	cw	DOMESTIC COLD WATER	<b>⊢</b> ⊢⇔		MANUAL BALANCING VALVE
<del></del>	HW	DOMESTIC	<b>├</b>		CHECK VALVE
		HOT WATER	<del>≻   ≻                                 </del>		STRAINER
— 140° — <b>~</b>	140°	DOMESTIC 140° HOT WATER	<b>₩</b>		GAS COCK
		DOMESTIC HOT	<b>←</b>    <b>-</b>		PIPING UNION
<b></b>	HWC	WATER CIRCULATING	<b>├──</b>		PIPE REDUCER
,	- ED		;— <del>1</del> 3€+—;		VALVE IN RISER
FP—	FP	FIRE PROTECTION			2-WAY CONTROL
<b>—</b> G <b>—</b> →	G	NATURAL GAS			VALVE
—CWS—	cws	CHILLED WATER SUPPLY			3-WAY CONTROL VALVE
<b>←</b> CWR <b>←</b>	CWR	CHILLED WATER RETURN	<del>  </del>	НВ	HOSE BIBB
←HWS←	HWS	HEATING WATER SUPPLY	<del>  </del>	FPWH	FREEZE PROOF WALL HYDRANT
<b>⊢</b> HWR <b>→</b>	HWR	HEATING WATER RETURN	0	FD	FLOOR DRAIN
← CTS ←	CTS	COOLING TOWER SUPPLY		FS	FLOOR SINK
		COOLING TOWER	(0)	RD/ORD	ROOF DRAIN
— CTR —	CTR	RETURN	-	wco	WALL CLEANOUT
— HPS —	HPS	HEAT PUMP SUPPLY	•	FCO	FLOOR CLEANOUT
—HPR→	HPR	HEAT PUMP RETURN	<b>○</b> + →	VTR	VENT THRU ROOF CLEANOUT
s	s	STEAM SUPPLY	<del>  </del>	CO	GLLANOUT
← CR ←	CR	STEAM CONDENSATE RETURN			
<b>—</b> R <b>→</b>	R	REFRIGERATION			
<u>— А</u>	CA	COMPRESSED			

PIPING

	1 1	0.450		
		SYMBOL	ABBR P1.1	DESCRIPTION PLUMBING FIXTURE
				NUMBER
			<u>F-1</u>	EQUIPMENT DESIGNATION
		(1)		PLAN NOTE
1			POC	POINT OF CONNECTION (CONNECT NEW TO EXISTING)
			(E)	EXISTING
			ABV	ABOVE
			BLW	BELOW
			DN	DOWN
.VE			BTWN	BETWEEN
			BOD	BOTTOM OF DUCT (ABOVE FINISHED FLOOR)
.VE -			ВОР	BOTTOM OF PIPE
			NTS	NOT TO SCALE
			AFF	ABOVE FINISHED FLOOR
_			CA	COMBUSTION AIR
			OA	OUTDOOR AIR
₹ R			EA	EXHAUST AIR
			SA	SUPPLY AIR
DL			RA	RETURN AIR
DL			TA	TRANSFER AIR
			EAT	ENTERING AIR TEMPERATURE
			LAT	LEAVING AIR TEMPERATURE
F IT			EWT	ENTERING WATER TEMPERATURE
1			LWT	LEAVING WATER TEMPERATURE
			DB	DRY BULB TEMPERATURE
			WB	WET BULB TEMPERATURE
			CLNG	COOLING
JT			HTNG	HEATING
UT			SAG	SUPPLY AIR GRILLE
OF			RAG	RETURN AIR GRILLE
			TAG	TRANSFER AIR GRILLE
			OBD	OPPOSED BLADE DAMPER
			PBD	PARALLEL BLADE DAMPER
			WPL	WEATHER PROOF LOUVER
			WT	WEIGHT
			ESP	EXTERNAL STATIC PRESSURE
			APD	AIR PRESSURE DROP
			WPD	WATER PRESSURE DROP
			PD	PRESSURE DROP
			СМ	CONSTRUCTION MANAGER
			GC	GENERAL CONTRACTOR
			МС	MECHANICAL CONTRACTOR
			PC	PLUMBING CONTRACTOR
			EC	ELECTRICAL CONTRACTOR
			TCC	TEMPERATURE CONTROLS CONTRACTOR
			UNO	UNLESS NOTED OTHERWISE
			RPZ	REDUCED PRESSURE ZONE ASSEMBLY
			PRV	PRESSURE REDUCING VALVE
		T		THERMOSTAT/SENSOR
		$\stackrel{\smile}{\mathbb{H}}$		HUMIDISTAT/SENSOR
	_	/ \		

**ABBREVIATIONS** 

	PROJEC	T DESIGN C	RITERIA		perty rig
LOCATION	COOLING DESIGN	HEATING DESIGN	ENERGY DESIGN	GOVERNING CODES	er pro
PROJECT CITY: MCPHERSON, KANSAS PROJECT ELEVATION: 1543 FT. ABOVE SEA LEVEL  ASHRAE CLIMATE DATA LOCATION: HUTCHINSON MUNICIPAL AIRPORT	DESIGN WEATHER BASIS: ASHRAE 0.4% DESIGN DRY BULB: 100.7° F MEAN COINC. WET BULB: 73.3° F  DESIGN WET BULB: 77.4° F MEAN COINC. DRY BULB: 91.4° F	DESIGN WEATHER BASIS: ASHRAE 99.6% DESIGN DRY BULB: 5.6° F	ASHRAE CLIMATE ZONE: 4A COOLING DEGREE DAYS(65): 1648 HEATING DEGREE DAYS(50): 1988	BUILDING CODE: 2018 INTERNATIONAL BUILDING COME: 2018 INTL. MECHANICAL CODE: 2018 INTL. PLUMBING CODE: ELECTRICAL CODE: 2017 NATIONAL ELECTRIC CODE: ENERGY CODE: 2010 ASHRAE 90.1 FIRE CODE: 2018 INTERNATIONAL FIRE CODE	ight and c

NITROGEN

VACUUM

**∼**VAC **→** VAC



801 E. DOUGLAS 2ND FLOOR WICHITA, KS 67202 INNOVATIVE GROUPS.COM

WALL SWITCH / SENSOR CARBON DIOXIDE SENSOR

INNOVATIVE GROUPS

 $11 \times 17 = 1/2 \text{ scale}$ 



Contract Date

Rev No. 2 Rev No. 3 Rev No. 6 Project Number: Designed By: Drawn By: Approved By: 3/25/24



### PLUMBING FIXTURE SCHEDULE

					E E	/	⊨			ROU	GH-IN S	IZES	TRIM & ACCESSORIES								
				٩L	≟	FLUSH VALVE / TANK	COMPLIANT	띪	S S	WA	STE	VENT		(D	ES	ΔNΤ	~	¥	ROU		
TAG	TYPE	MANUFACTER / MODEL	SIZE	MATERIAL	9	+ VA ANK	ОМР	CARRIER	MOUNTING HEIGHTS	111 111	> 111	111 111	MANUFACTER /	ITING HTS	HOLES	OMPLIANT	INER	SPRAY	IN S	ZES	NOTES
				MA	MOUNTING	LUSI	ADA C	CA	ᅙ	ABOVE GRADE	BELOW GRADE	ABOVE GRADE	MODEL	MOUNTIN HEIGHT	AUCET	S S	STRAINER	Ξ S	COLD	НОТ	
					M	正	AL			g A	B 15	g g		≥∸	FAU	ADA	S	HOSE	S	Ī	
P1.1	scs	AMERICAN STANDARD/PEKO	17x17x8	SS	UC	_	_	-	_	1-1/2"	2"	1-1/2"	AMERICAN STANDARD / STUDIO S 7105801	_	3	Х	Α		1/2"	1/2"	1,3,4
P1.2	scs	AMERICAN STANDARD/PEKO	25x22x9	ss	UC	_	_	_	_	1-1/2"	2"	1-1/2"	AMERICAN STANDARD / STUDIO S 4803300	_	1	Х	_		1/2"	1/2"	2,3,4
P1.3	TCS	PROVIDED BY KES	_	ss	F	-	_	_	_	1-1/2"	2"	1-1/2"	PROVIDED BY KES	_		_	_		3/4"	3/4"	_
P2	IMB	GUYGRAY/MIB1HAAB	7x7	_	W	_	_	_	_			_				_	_		1/2"		_
P3	WBF	ELKAY/LBWDC00	5-1/8x18x28	ss	W	_	Х	_	Α	1-1/4"	2"	1-1/2"		_		_	_		1/2"		
P4	DB	GUYGRAY/T200LV	14x9	_	W	_		_		2"	2"	1-1/2"			_				_	_	

GENERAL NOTES:

A. WHERE TRIM IS NOT CONCEALED BY ARCHITECTURAL APRON/CASEWORK, PROVIDE ADA COMPLIANT LAVATORIES & SINKS WITH TRUEBRO MODEL 103 INSULATION KIT WITH P-TRAP COVER, OFFSET TAILPIECE WHEEL CHAIR COVER, TWO ANGLE STOPS WITH SUPPLY COVERS.

#### NOTES: 1. PROVIDE FAUCET WITH RIGID SPOUT.

2. PROVIDE FAUCET WITH SWIVEL SPOUT.

B. ELECTRONIC SENSOR OPERATED FLUSH VALVES AND FAUCETS SHALL BE BATTERY POWERED.

3. PROVIDE LEAD-FREE POWERS 480 (OR EQUAL) THERMOSTATIC MIXING VALVE. OUTLET TEMPERATURE FROM FAUCET SHALL BE SET 110°F. 4. FAUCET FINISH OPTION MATTE BLACK.

#### PLUMBING FIXTURE LEGEND

TYPE	MATERIAL	MOUNTING TYPE	MOUNTING HEIGHTS	STRAINER
SCS SINGLE COMP SINK TCS TRIPLE COMP SINK WBF WATER BOTTLE FILLER IMB ICE MAKER BOX	SS STAINLESS STEEL	F FLOOR W WALL HUNG UC UNDER- COUNTER	A BOTTLE FILLER SENSOR AT 47" AFF (MAX)	A GRID

# AIR TERMINAL SCHEDULE

TAG	MODEL	STYLE	USE	LOCATION	MOUNTING	MATERIAL	FINISH	OBD FD	RD	NOTES
А	TDC	LOUVERED	SUPPLY	CEILING	LAY-IN/SURFACE	STEEL	WHITE PAINT			
В	50F-B	EGGCRATE	RETURN	CEILING	LAY-IN	ALUMINUM	BLACK PAINT			1
С	ML-39	LINEAR SLOT	SUPPLY	WALL / DUCT	SURFACE	STEEL	WHITE PAINT			2

GENERAL NOTES:

A. AIR TERMINALS ARE BASED ON TITUS.

B. BRANCH DUCT SIZE SHALL BE SAME AS NECK SIZE UNLESS OTHERWISE SHOWN ON PLANS.

PROVIDE RECTANGULAR TO ROUND ADAPTERS AS REQUIRED. D. PROVIDE SURFACE MOUNTING FRAMES AS REQUIRED.

E. BLADES SHALL BE PARALLEL TO THE LONG DIMENSION UNLESS NOTED OTHERWISE.

F. ALL SURFACES VISIBLE THROUGH THE FACE OF THE AIR TERMINAL SHALL BE PAINTED FLAT BLACK.

NOTES:

1. PROVIDE WITH 12x24 OR 24x24 LAY-IN PANEL AS INDICATED ON PLANS PROVIDE MPI-39 INSULATED PLENUM FOR MODULINEAR SLOT DIFFUSER.

#### AIR TERMINALS LEGEND

		OPPOSED BLADE DAMPER FIRE DAMPER	` A-8x	-	IF NECK SIZE IS NOT INDICATED SIZE SHALL CORRESPOND TO
RD	=	RADIATION DAMPER	100		BRANCH DUCT SIZE INDICATED ON
			(CFN	/I)	PLAN

# MINISPLIT SYSTEM SCHEDULE

OUTDOOR IN	INDOOR		INDOOR UNIT								OUTDOOR UNIT ELECTRI		TRICAL							
UNIT	NIT UNIT	MODEL	MODEL	MODEL	MODEL	MODEL	MODEL	MODEL	TYPE	F	AN	CLNG. C	APACITY	HTNG.	WT.	MODEL	WT.	MCA	MOCP	NOTES
TAG	TAG	MODEL	ITPE	FLOW	ESP	TOTAL	SENS.	CAP.	VVI.	MODEL	VV 1.	IVICA	MOCP							
	DSS-1A	NTXCKS09A112BA	4-WAY CLNG CASS	335	0.0	7.2	7.1	7.3	31											
DSS-1	DSS-1B	NTXCKS09A112BA	4-WAY CLNG CASS	335	0.0	7.2	7.1	7.3	31	NTXMPH24A132AA	189	30.5	40	1						
	DSS-1C	NTXCKS09A112BA	4-WAY CLNG CASS	335	0.0	7.2	7.1	7.3	31											

A. MINISPLIT SYSTEMS ARE BASED ON MITSUBISHI ELECTRIC TRANE HVAC US.

B. COOLING CAPACITIES BASED ON 80°F DB/67°F WB INDOOR UNIT ENTERING AIR TEMPERATURE, 95°F DB OUTDOOR UNIT AMBIENT TEMPERATURE. HEATING CAPACITIES BASED ON 70°F DB INDOOR UNIT, 43°F WB OUTDOOR UNIT.

INDOOR UNITS ARE POWERED FROM OUTDOOR UNITS. ALL SYSTEMS 208-230V/1Ø UNLESS NOTED OTHERWISE.

FAN FLOW FOR DUCTLESS TYPE UNITS SHOWN FOR REFERENCE ONLY. TAB CONTRACTOR SHALL NOT ATTEMPT TO BALANCE UNIT FAN. PROVIDE SIMPLE MA PROGRAMMABLE WIRED CONTROLLER FOR EACH INDOOR UNIT.

H. REFRIGERANT PIPING SHALL BE SIZED BY UNIT MANUFACTURER ACCOUNTING FOR LENGTH, ELBOWS, ELEVATION DIFFERENCE, ETC

ALL CEILING CASSETTE UNITS SHALL BE PROVIDED WITH WASHABLE FILTER. PROVIDE ONE (1) EXTRA SET FOR EACH INDOOR UNIT. G. PROVIDE HAIL GUARDS ON ALL OUTDOOR UNITS.

NOTES:

1. PROVIDE INTERNAL CONDENSATE PUMP. PUMP TO BE POWERED BY INDOOR UNIT.

Farmers 1122 Nor

Contract Date Rev No. 2 Rev No. 3 Rev No. 4 Rev No. 5 Rev No. 6 Project Number: DWG File Designed By: Drawn By: Approved By: 03/25/24



SHEET NUMBER

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INNOVATIVE GROUPS

 $11 \times 17 = 1/2 \text{ scale}$ 

1 DIFFUSER CONNECTION DETAIL

MINI SPLIT SUPPORT STAND BASED ON BIG FOOT SYSTEM SYSTEMS. PROVIDE STAND BASED ON HEAT OUTDOOR UNIT-PUMP MANUFACTURER AND MODEL. AS SCHEDULED. 2. PROVIDE MANUFACTURERS RECOMMENDED CLEARANCES. COORDINATE LOCATION OF STAND FEET WITH STRUCTURE. ENSURE ADEQUATE ORIENT UNIT FOR WEST OR EAST FAN 4. INSTALL HEAT MINI SPLIT TO STAND PER DISCHARGE WHERE -MANUFACTURER RECOMMENDATIONS. PRACTICAL. — VIBRATION ISOLATION PADS (TYP) ► HOT DIPPED GALVANIZED CARBON STEEL FRAME SUPPORT. SET 8"x8" PLASTIC FEET SUPPORTS ON (ROOF) MEMBRANE IN MASTIC (APPROVED BY ROOF MANUFACTURER)


2 MINISPLIT OUTDOOR UNIT MOUNTING DETAIL
NO SCALE

- MANUAL BALANCE DAMPER WITH LOCKING QUADRANT IN ALL BRANCH DUCTS ACCESSIBLE THROUGH CEILING SERVING AIR DEVICE WITH AIRFLOW INDICATED IN TAG, OR WHERE SHOWN ON PLANS. PROVIDE 2" STANDOFF ON EXTERNALLY RECTANGULAR TRUNK OR BRANCH DUCT .-INSULATED DUCTWORK. DAMPER NOT REQUIRED ON BRANCH DUCTS SERVING . . . . . . . . . AIR DEVICE WITH OBD. RECTANGULAR MAIN OR TRUNK DUCT. · 45° TAKEOFF FITTING, LENGTH PER SMACNA STANDARDS. POSITIVE PRESSURE AIRFLOW NEGATIVE PRESSURE AIRFLOW

RECTANGULAR-TO-RECTANGULAR

DUCT TAKEOFF DETAIL


NO SCALE

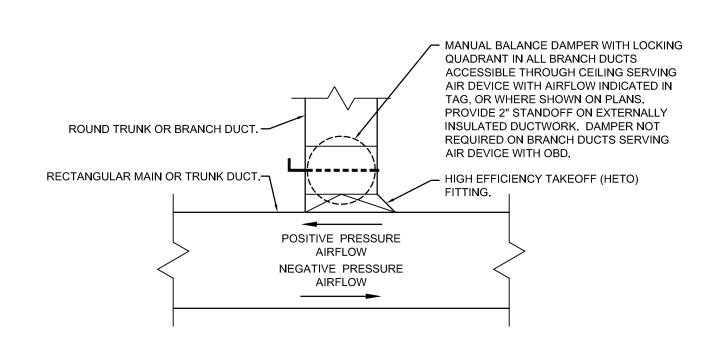


RECTANGULAR-TO-ROUND


DUCT TAKEOFF DETAIL

NO SCALE

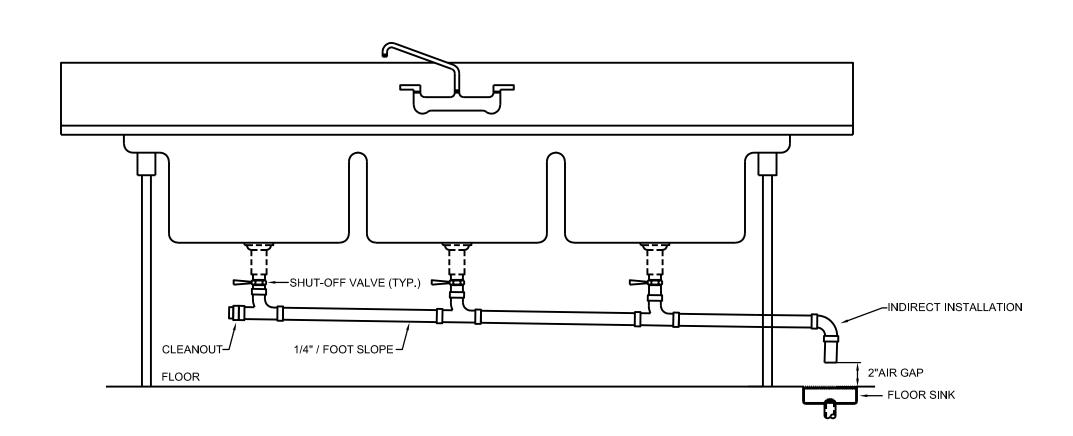


7 CONTINUOUS DRAIN FITTING DETAIL

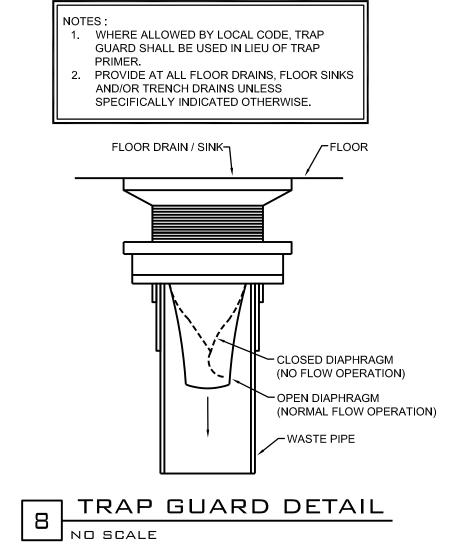

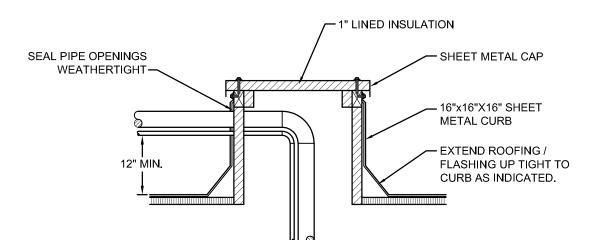

REFRIGERANT PIPING CURB DETAIL

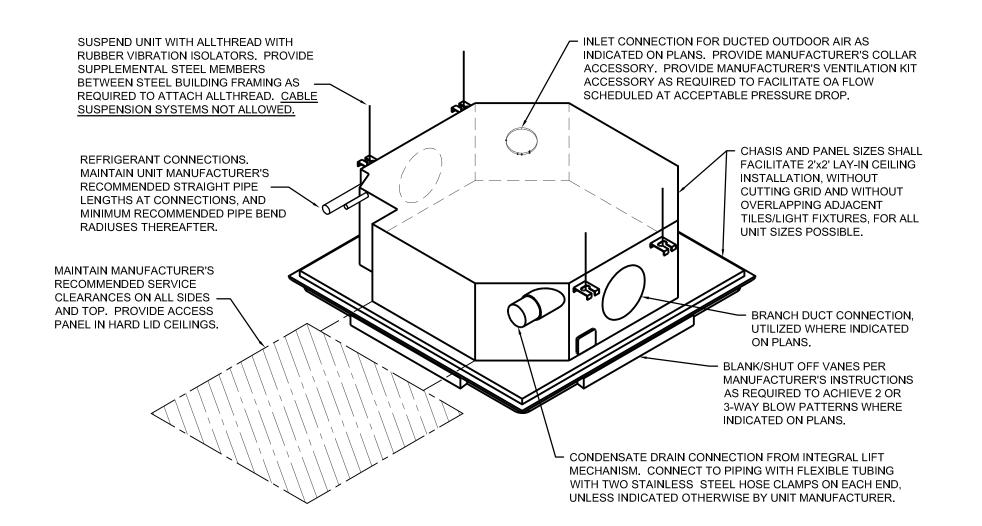

6 NO SCALE



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ARCHITECTURE DESIGN WWw.plan4ar

Farmers Alliance Mutual Insu 1122 North Main

Contract Date

Rev No. 1

Rev No. 2

Rev No. 3

Rev No. 4

Rev No. 5

Rev No. 6

Project Number: 22.31

DWG File

Designed By: CRS

Drawn By: KGB

Approved By: plan4

Date: 03/25/24



SHEET NUMBER

MP201

# PLAN NOTES:

- 1 REMOVE PLUMBING FIXTURE. DEMO AND CAP HW / CW / RO H20 PIPE / WASTE PIPING UNDER FLOOR IN OLD STAIRWELL AND PREP FOR NEW WORK. VENT PIPING TO BE CAPPED ABOVE CEILING AND PREP FOR RECONNECTION.
- 2 DEMO AND CAP CW PIPING SERVING ICE MAKER & BEVERAGE DISPENSERS BACK TO MAIN IN BASEMENT.
- REMOVE DRAIN PIPING SERVING ICE MAKER & BEVERAGE DISPENSERS IN THEIR ENTIRETY. REMOVE HUB DRAIN & PIPING BACK TO MAIN IN BASEMENT AND PREP FOR NEW DRAIN BOX.
- 4 RO WATER FILTRATION SYSTEM AND PIPING IS BELOW FLOOR IN OLD STAIRWELL.
- REMOVE 1-1/4" HW PIPING THIS AREA AND CAP. PREP CONNECTION FOR NEW WORK REQUIREMENTS INDICATED ON SHEET P101.

LAN NOTES.

, changed, copied or assigned to any third party, in any form or ma DEMO PLAN

Rev No. 6

DWG File

Designed By:

Approved By:

Drawn By:

Project Number:


Contract Date

Rev No. 1

Rev No. 3

Rev No. 4

Rev No. 5

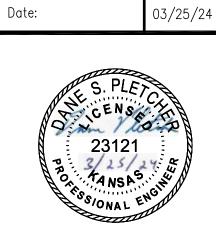

SHEET NUMBER

PD101

80 21 W IN

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INNOVATIVE GROUPS

 $11 \times 17 = 1/2 \text{ scale}$ 

- 1 EXTEN VENT PIPING FROM SINK TO EXISTING VTR RETAINED DURING DEMOLITION.
- 2) ROUTE 3/8" RO WATER PIPING / 3/4" DRAIN PIPING THROUGH HOLE IN COUNTER TOP TO CONNECT TO ICE/WATER MACHINE AND 1/4" RO WATER PIPING TO CAPPUCCINO MACHINE. DRAIN PIPING SHALL CONNECT TO SIOUX CHIEF TAILPIECE FITTING UPSTREAM OF SINK TRAP THIS AREA.
- (3) EXTEND 1/2" CW PIPING ALONG BACK WALL OF CABINET SPACE UP TO COFFEE / TEA MACHINES THIS AREA. INSTALL INLINE FILTER (PROVIDED BY OWNER) PRIOR TO CONNECTION. INSTALL AND CONNECT PER MFGR REQUIREMENTS.
- 4 ROUTE 1" CW / HW PIPING DOWN IN WALL TO BASEMENT THIS AREA. EXTEND PIPING TO EXISTING MAINS AS INDICATED.
- TO ROUTE WASTE PIPING IN BASEMENT WHILE AVOID EXISTING UTILITIES / PIPING / DUCT. FIELD-VERIFY EXACT ROUTING AND CONNECTION REQUIREMENTS PRIOR TO INSTALLATION.
- 6 ROUTE ICE MAKER DRAIN PIPING TIGHT ALONG WALL TO FLOOR SINK AND TERMINATE WITH 2" AIR GAP. CONNECT CW PIPING TO WATER FILTER WITH ICE MAKER.
- 7 REFER TO CONTINUOUS DRAIN FITTING DETAIL FOR SINK DRAIN PIPING INSTALLATION REQUIREMENTS.
- 8 EXTEND W PIPING RETAINED DURING DEMOLITION TO DRAIN BOX IN WALL AT 72" AFF.
- 9 ROUTE DISHWASHER WASTE PIPING TO FLOOR SINK AND TERMINATE WITH 2" AIR GAP.

Contract Date Rev No. 2 Rev No. 3 Rev No. 4 Rev No. 5 Rev No. 6 Project Number: DWG File Designed By: Drawn By: Approved By: 03/25/24



SHEET NUMBER

P101

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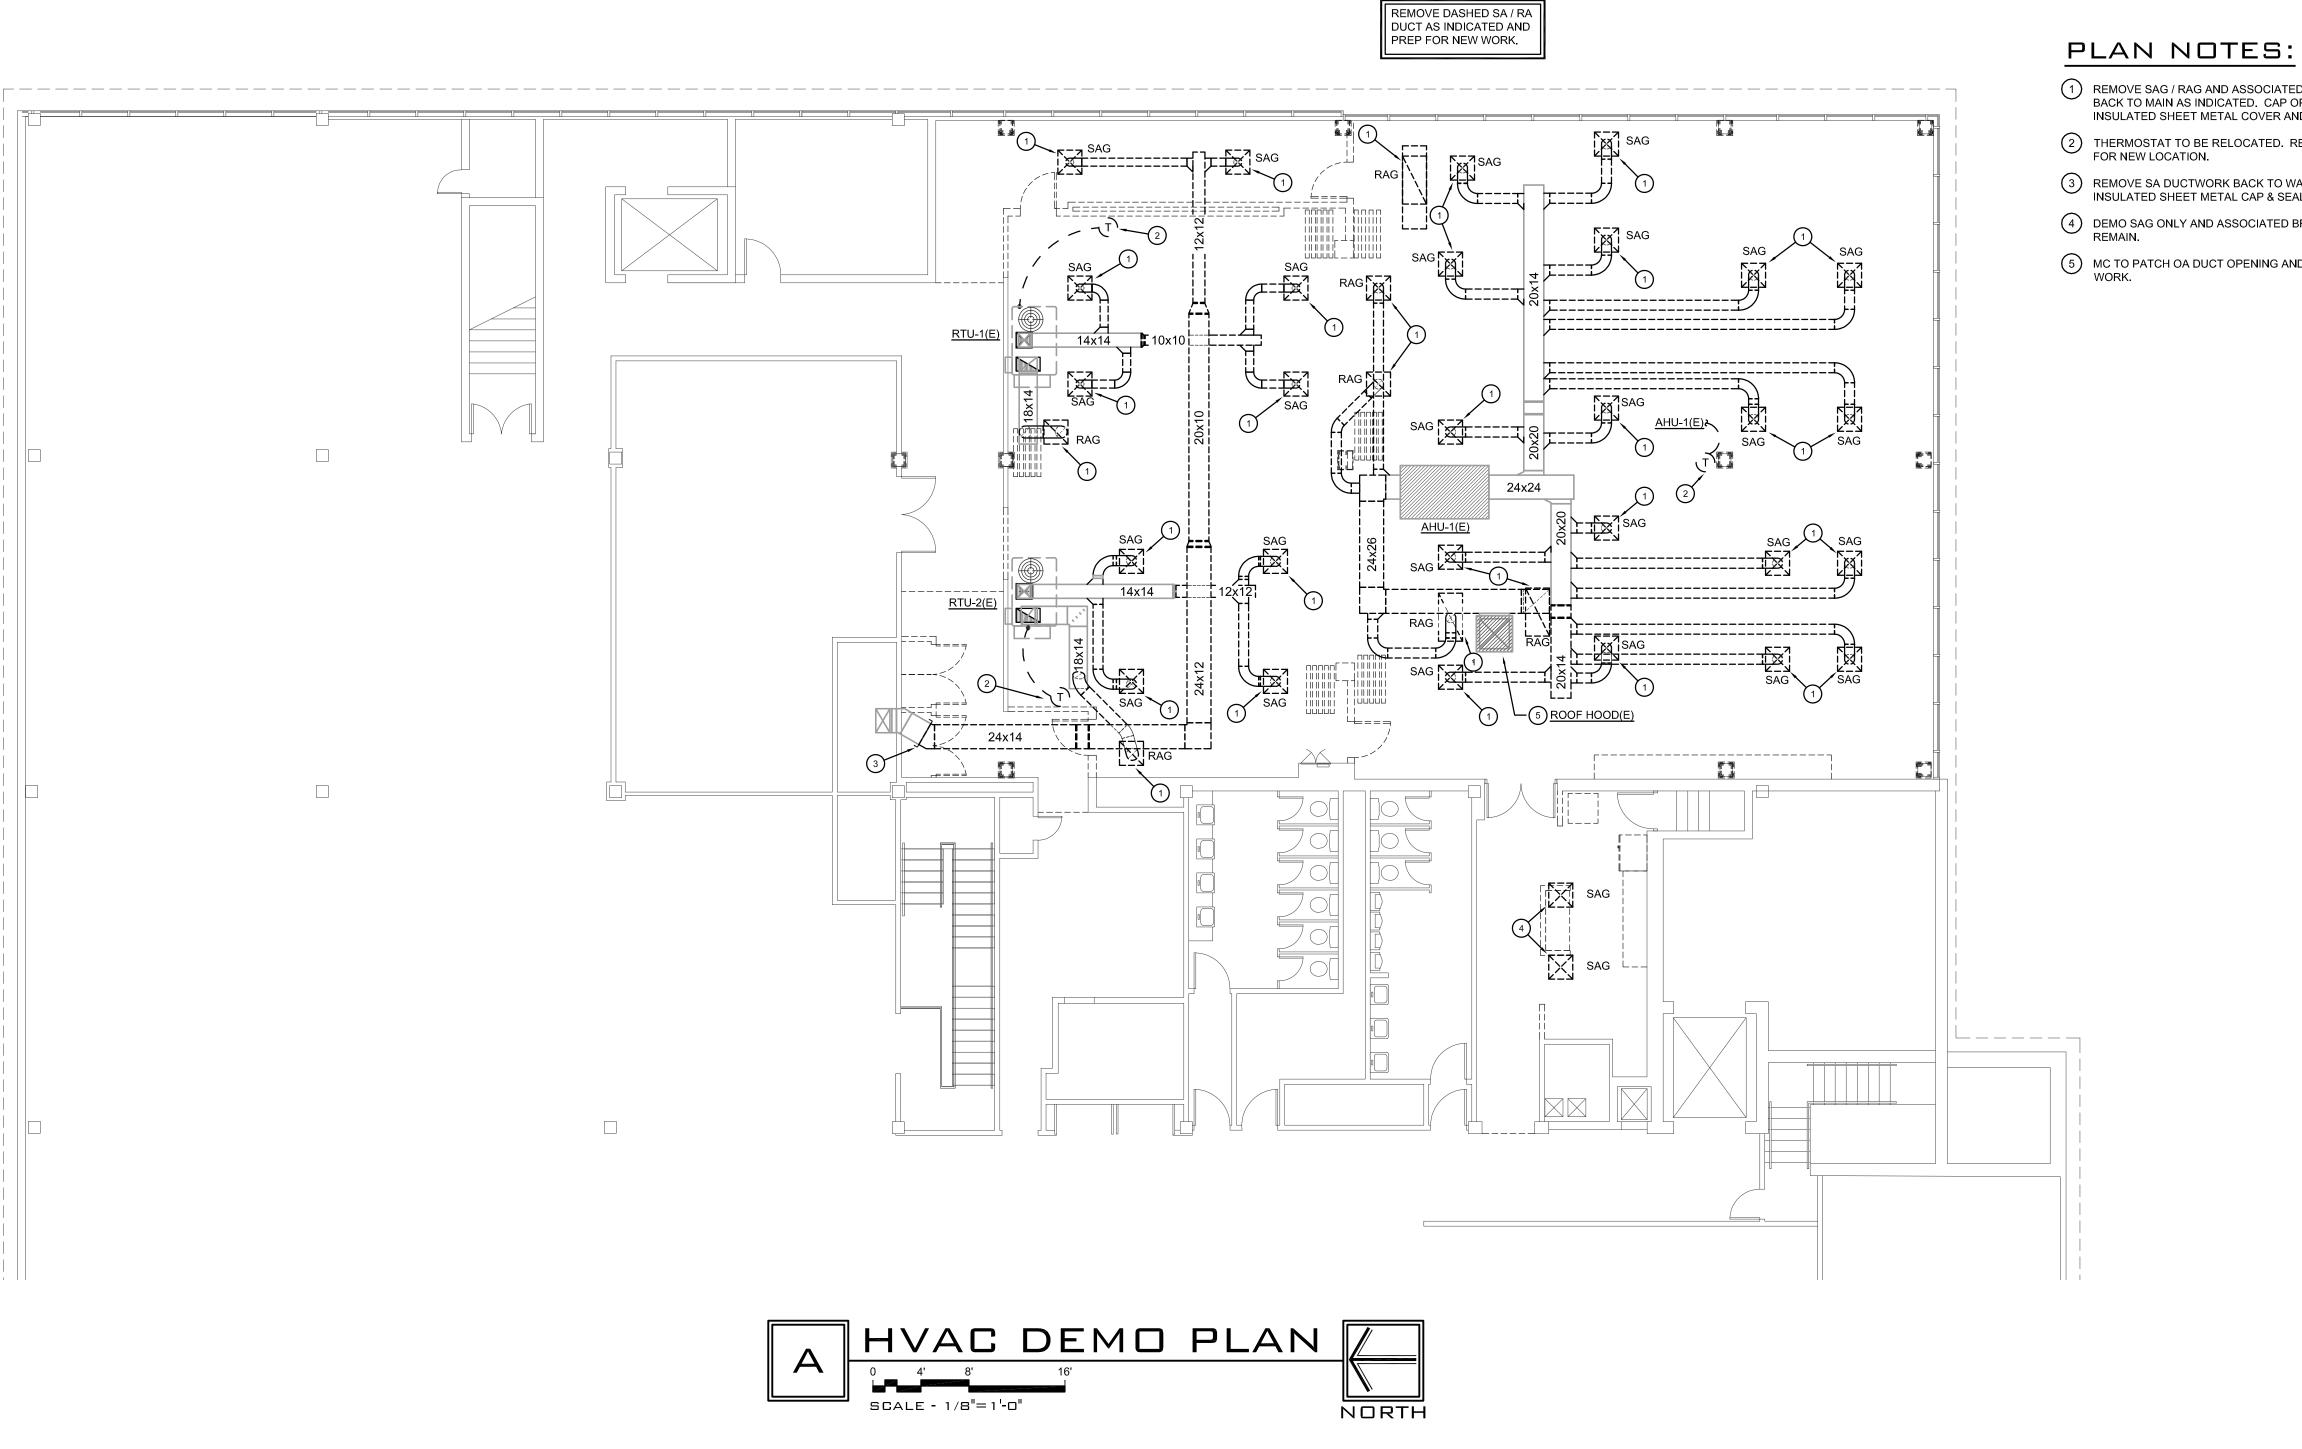
INNOVATIVE GROUPS

 $11 \times 17 = 1/2 \text{ scale}$ 

PLUMBING PLAN

O 4' 8' 16'


SCALE - 1/8"=1'-0"





- 1 REMOVE SAG / RAG AND ASSOCIATED BRANCH DUCTWORK BACK TO MAIN AS INDICATED. CAP OPENING WITH 1" INSULATED SHEET METAL COVER AND SEAL AIRTIGHT.
- 2 THERMOSTAT TO BE RELOCATED. REFER TO SHEET M101 FOR NEW LOCATION.
- 3 REMOVE SA DUCTWORK BACK TO WALL AND CAP WITH 1" INSULATED SHEET METAL CAP & SEAL AIRTIGHT.
- demo sag only and associated branch ductwork to REMAIN.
- 5 MC TO PATCH OA DUCT OPENING AND PREP FOR NEW WORK.

Contract Date Rev No. 2 Rev No. 3 Rev No. 4 Rev No. 5 Rev No. 6 Project Number: DWG File Designed By: Drawn By: Approved By: 03/25/24

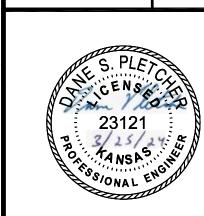

SHEET NUMBER

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INNOVATIVE GROUPS

 $11 \times 17 = 1/2 \text{ scale}$ 

# PLAN NOTES:

- PROVIDE TDC-3 GRILLE. EXTEND EXISTING SA DUCTWORK TO GRILLE LOCATIONS INDICATED. CONTRACTOR SHALL FIELD VERIFY NECK SIZE PRIOR TO INSTALLATION.
- 2 PROVIDE PLASTER FRAME FOR SUPPLY GRILLE THIS AREA.
- 3 ROUTE REFRIGERATION PIPING DOWN THROUGH ROOF TO ASSOCIATED INDOOR UNITS. INSTALL PER MANUFACTURER RECOMMENDATIONS.
- 4 ROUTE SA DUCTWORK THROUGH STRUCTURE THIS AREA. FIELD-VERIFY EXACT LOCATION.
- 5 CONTRACTOR SHALL BALANCE AIR HANDLER TO CFM'S INDICATED ON PLAN. ADJUST HYDRONIC BALANCING VALVE TO ALLOW FOR 55° F LAT DURING COOLING AND 95° F LAT DURING HEATING. ALLOW FOR BELT, SHEAVES, ETC. AS REQUIRED.
- 6 BALANCE OUTSIDE AIR TO 640 CFM.
- 7 COORDINATE ROUTING OF CONDENSATE PIPING WITH PLENUM BOXES.
- 8 ROUTE CONDENSATE PIPING UP TIGHT TO SIMPLE SAVER INSULATION FROM CASSETTE AND ROUTE CONDENSATE PIPING AS INDICATED.

C PLAN

Contract Date

Rev No. 1

Rev No. 2

Rev No. 3

Rev No. 4

Rev No. 5

Rev No. 6

Project Number: 22.31


DWG File

Designed By: CRS

Drawn By: KGB

Approved By: plan4

Date: 03/25/24

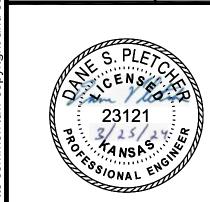

SHEET NUMBER

M101

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INNOVATIVE GROUPS

 $11 \times 17 = 1/2 \text{ scale}$ 

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# **ELECTRICAL NOTES**

- WIRING SHALL BE IN ACCORDANCE WITH THE LATEST ADOPTED EDITION OF THE NATIONAL ELECTRICAL CODE (NEC), AND / OR APPLICABLE LOCAL, STATE, AND UTILITY COMPANY RULES, LAWS, AND ORDINANCES.
- SECURE ALL PERMITS AND INSPECTIONS REQUIRED FOR INSTALLATION OF ELECTRICAL WORK, VERIFY ALL OUTLET LOCATIONS ON JOB PRIOR TO ROUGH-IN. COORDINATE ALL OUTLET BOX LOCATIONS WITH MASONRY, IF ANY, TO MINIMIZE CUTTING AND PATCHING OF BOTH BRICK AND BLOCK.
- THE ELECTRICAL CONTRACTOR SHALL COOPERATE WITH OTHER CONTRACTORS, INSTALL EQUIPMENT IN PROPER SEQUENCE AS NOT TO INTERFERE WITH THE PROGRESS OF OTHER CONTRACTORS, AND GIVE GENERAL CONTRACTOR ALL NECESSARY INFORMATION FOR MAKING PROPER PROVISION FOR INSTALLATION OF HIS EQUIPMENT.
- ALL MATERIALS SHALL BE NEW, UNLESS OTHERWISE NOTED ON DRAWINGS, CARRY UNDERWIRITER'S LABEL, OR BE "LISTED" BY THAT GROUP AND BE FULLY EQUAL TO MAKES SPECIFIED.
- ON RATED WALLS AND SEPARATION WALLS, ALL ELECTRICAL OUTLETS AND SWITCH BOXES ARE REQUIRED TO MEET I.B.C. 711 THRU 714.
- INDIVIDUAL HOME-RUNS ARE SHOWN FOR CLARITY ONLY. E.C. CAN COMBINE THEN TOGETHER PER LATEST "NEC". ALL WIRE IS No. 12 THHN COPPER UNLESS OTHER WISE NOTED. ANY 120 VOLT OR 208 VOLT HOME-RUN WITH A DISTANCE LONGER THAN 80' FROM THE PANEL TO THE FIRST DEVICE, OR 277 VOLT OR 480 VOLT HOME-RUN WITH A DISTANCE LONGER THAT 160' FROM THE PANEL, SHALL BE UPSIZED TO ALLOW FOR VOLTAGE DROP. SEE DRAWINGS AND SCHEDULES.
- USE ONLY INSULATED COPPER CONDUCTORS IN CONDUIT WITH A MINIMUM SIZE TO BE 1/2" TRADE SIZE, OR "MC" CABLE IF APPROVED BY LOCAL CODE. USE FLEXIBLE CONDUIT FOR CONNECTIONS TO MOTORS, TRANSFORMERS, AND SIMILAR EQUIPMENT. ALL WIRING SHALL BE CONCEALED, FLUSH OUTLETS, EXCEPT AS NOTED ON DRAWINGS. WIRE INSULATION SHALL BE COLOR COATED AS FOLLOWS OR PER LOCAL ORDNANCES: 120/208V, 3Ø - A-BLACK, B-RED, C-BLUE, NEUTRAL-WHITE, G-GREEN. 277/480V, 3Ø -A-BROWN, B-ORANGE, C-BLUE, NEUTRAL-GRAY, G-GREEN.
- BRANCH CIRCUIT PANELBOARDS SHALL BE AS NOTED ON DRAWINGS WITH THERMAL MAGNETIC BREAKERS. BREAKERS SHALL HAVE INDIVIDUAL PLASTIC CASES, SIZED AS SCHEDULED. TWO AND THREE POLE BREAKERS SHALL BE COMMON TRIP (SINGLE POLE UNITS WITH COMMON TRIP ARE NOT ACCEPTED). ALL BREAKERS ARE TO BE BOLT-IN. FURNISH AND INSTALL A NEATLY TYPED DIRECTORY CARD, LOCATED ON THE INSIDE OF THE HINGED DOOR. REASSIGN CIRCUITS TO PROPERLY BALANCE THE LOADS ON THE PHASE IF THE FINAL CONNECTIONS AND TEST SHOW IT TO BE ADVISABLE..
- ALL PENETRATIONS IN THE RATED WALLS, FLOOR / CEILING ASSEMBLY, AND THE ROOF / CEILING ASSEMBLY SHALL BE SEALED WITH A MATERIAL CAPABLE OF PREVENTING THE PASSAGE OF FLAME AND HOT GASES. THE SEALER SHALL HAVE A T-RATING AND F-RATING OF NOT LESS THAN THAT OF THE WALL, FLOOR, OR CEILING BEING PENETRATED. THE ABOVE REQUIREMENTS SHALL MEET I.B.C. 711 THRU 714. A MAXIMUM OF TWO OUTLET BOXES PER STUD SPACE IN THE RATED WALLS. THE MAXIMUM SIZE FOR STEEL OUTLET BOXES ON 100 SQUARE INCHES FOR ANY 100 SQUARE FEET OF WALL AREA. BOXES ON OPPOSITE SIDES OF FIRE WALLS SHALL BE SEPARATED BY A HORIZONTAL DISTANCE OF NOT LESS THAN 24 INCHES, I.B.C. 711 & 714.
- 10. ALL CONDUIT AND OUTLET BOXES (ELECTRICAL, TELEPHONE, COMPUTER, DATA, ECT.) LOCATED IN THE RATED WALLS, FLOOR, CEILING, OR ROOF SHALL BE CONSTRUCTED OF A NON-COMBUSTABLE MATERIAL
- 11. ELECTRICAL EQUIPMENT SHALL BE INSTALLED IN A NEAT WORKMANLIKE MANNER. UNSIGHTLY INSTALLATIONS SHALL BE REMOVED AND REWORKED AT NO ADDITIONAL EXPENSE TO THE OWNER.
- 12. WIRING OF MECHANICAL EQUIPMENT FURNISHED BY OTHERS: FURNISH AND INSTALL ALL POWER WIRING, AND ALL CONTROL WIRING AND INTERLOCK WIRING OF ALL UNITS. PUMPS. FANS. WATER HEATERS. ETC. CONNECT PER MANUFACTURERS WIRING DIAGRAMS. FURNISH AND INSTALL ALL NECESSARY DISCONNECT DEVICES AS REQUIRED. CONTRACTOR TO VERIFY THE ACTUAL WIRING SIZING AMPS FOR ALL EQUIPMENT FROM THE EQUIPMENT NAMEPLATE, ELECTRICAL INSTALLATION SHALL BE BASED ON ACTUAL REQUIRED AMPERAGES, WHICH MAY VERY SOMEWHAT FROM THE WIRE AND EQUIPMENT SIZES SHOWN ON THE DRAWINGS. PROPERLY SIZED ELECTRICAL WIRING AND EQUIPMENT SHALL BE FURNISHED WITHOUT ANY ADDITIONAL COST TO THE CONTRACT. THE CONTRACTOR SHALL NOTIFY THE ENGINEER OF ALL CHANGES TO BE MADE IN THE ELECTRICAL INSTALLATION DUE TO EQUIPMENT VARIANCES SO THAT THE IMPACT ON FEEDERS, PANELS, FUSE AND BREAKER SIZES CAN BE CHECKED PRIOR TO INSTALLATION.
- 13. WIRING OF THERMOSTATS AND TEMPERATURE CONTROLS: FURNISH AND INSTALL ALL POWER WIRING, AND ALL CONTROL AND INTERLOCK WIRING OF ALL THERMOSTATS AND TEMPERATURE CONTROL DEVICES INCLUDING NIGHTSTATS, TIME SWITCHES, OVERRIDE TIMERS, ETC. SEE MECHANICAL DRAWINGS FOR LOCATIONS AND TEMPERATURE CONTROL DIAGRAMS.
- 14. THE DRAWINGS SHOWING THE LAYOUT OF THE WORK INDICATE THE APPROXIMATE LOCATIONS OF OUTLETS, APPARATUS, AND EQUIPMENT. THE DRAWINGS ARE SCHEMATIC ONLY, AND ARE NOT INTENDED TO SHOW EXACT ROUTING OF CONDUIT, ETC. THE FINAL DETERMINATION AS TO THE ROUTING SHALL BE GOVERNED BY THE STRUCTURAL CONDITIONS AND OTHER OBSTRUCTIONS. THEY SHALL NOT BE CONSTRUED TO MEAN THE DESIGN OF THE SYSTEM MAY BE CHANGED. IT MERELY REFERS TO THE EXACT RUN OF A RACEWAY BETWEEN GIVEN POINTS. THE CONTRACTOR SHALL CONSULT ALL CONTRACT DRAWINGS WHICH MAY AFFECT THE LOCATION OF ANY OUTLET, APPARATUS, OR EQUIPMENT TO AVOID POSSIBLE INTERFERENCE AND PERMIT FULL COORDINATION OF ALL WORK. THE RIGHT TO MAKE ANY REASONABLE CHANGE IN THE LOCATION OF OUTLETS, APPARATUS, AND EQUIPMENT UP TO THE TIME OF ROUGH-IN IS RESERVED BY THE ARCHITECT WITHOUT INVOLVING ANY ADDITIONAL EXPENSE TO THE
- 15. THE TELEPHONE / DATA SYSTEM SHALL CONSIST OF A CONDUIT SYSTEM ONLY. 1" MINIMUM. IN WALLS FROM THE OUTLET BOX STUBBED INTO THE CEILING CAVITY. ALL COVER PLATES, CONNECTORS, TELEPHONE / DATA WIRES, AND FINAL TERMINATIONS ARE BY OTHERS. COORDINATE ACTUAL AMOUNT OF OUTLET AND LOCATIONS WITH THE OWNER PRIOR TO ROUGH-IN.
- 16. IT IS THE RESPONSIBILITY OF THE ELECTRICAL CONTRACTOR PROVIDE THE UTILITY CO. WITH THE ELECTRICAL LOADS AND FILL OUT ALL APPROPRIATE PAPERWORK AND FORMS.

	EL	ECTRICAL DEVICE	SCHED	JLE	
SYM	DESCRIPTION	MFGR. & CAT No.	RATING	MOUNTING	REMARKS
\$	SINGLE POLE SWITCH	PASS & SEYMOUR PS20AC1-I	20A 125 / 277V	48" A.F.F. TO TOP	
\$3	THREE WAY SWITCH	PASS & SEYMOUR PS20AC3-I	20A 125 / 277V	48" A.F.F. TO TOP	
\$D \$D3	DIMMER SWITCH	LUTRON DVSTV	8A 125 / 277V	48" A.F.F. TO TOP	
Ф	DUPLEX RECEPT.	PASS & SEYMOUR TR5362-I	20A 125V	16" A.F.F. TO BOTTOM	
<b>6</b>	G.F.I. DUPLEX RECEPT.	PASS & SEYMOUR 2094-TRI	20A 125V	16" A.F.F. TO BOTTOM	W/ TAYMAC # ML500G COVER PLATE
Ф	SINGLE GFCI RECEPTACLE	PASS & SEYMOUR 2097TRSGLW	20A 125V	16" A.F.F. TO BOTTOM	
$\oplus$	RECEPT. / USB OUTLET	PASS & SEYMOUR TR5362USB-I	20A 125V	16" A.F.F. TO BOTTOM	
0	NEMA-1 JUNCTION BOX	STEELCITY 4"x4" BOX		AS REQUIRED	
$\Diamond$	T.V. OUTLET	STEELCITY 2"x4" BOX		16" A.F.F. TO BOTTOM	WITH 1" C. TO ABOVE CLG.
▼	TELEPHONE / DATA OUTLET	STEELCITY 2"x4" BOX		16" A.F.F. TO BOTTOM	WITH 1" C. TO ABOVE CLG.
①	THERMOSTAT	FURN. BY M.C.; INST. & CONN. BY E.C.		48" A.F.F. TO TOP	
<b>\</b>	MOTOR	FURN. & INST. BY M.C.; CONN. BY E.C.		AS REQUIRED	
a,b,c	DENOTES SWITCH SCHEME				
1,3,5	DENOTES CIRCUIT NUMBERS				
/ <del>+ </del> \	3/4" CONDUIT WITH PULLWIRE			UNDER FLOOR	
/# \	BRANCH CIRCUIT	WITH NUMBER OF WIRES		UNDER FLOOR	
	BRANCH CIRCUIT	WITH NUMBER OF WIRES		ABOVE FLOOR	
_	HOME RUN	WITH NUMBER OF WIRES		ABOVE FLOOR	

- 2. ALL 125V NON-LOCKING RECEPTACLES MOUNTED BELOW 5'-6" A.F.F. SHALL BE TAMPER RESISTANT TYPE PER N.E.C. 406-12.
- 3. REGARDLESS OF CONTROL REQUIREMENTS ALL FEEDERS FROM SWITCH TO FIRST LIGHT FIXTURE SHALL INCLUDE LOW-VOLTAGE CONTROL WIRES.

	LIGHTING FIXTURE SCHEDULE							
SYM	DESCRIPTION	MFGR.	CAT No.	TYPE	LAMP CODE	MOUNTING	NOTES	
A	BOOTH AREA PENDANT	TECH LIGHTING	700 TD Y B - LED927	LED	493 lm (100W)	PENDANT / CEILING	-	
В	8' LINEAR PENDANT	ZANEEN	IDAHO 75 LE1D75-SUS-SYS 8' & 10' FIXTURES	LED	4566 lm (52.5W)	PENDANT / CEILIING	4	
С	36" LED ROUND PENDANT	SOLERA	CIRC-II-36-36W-6360-4000K-UNV-3AC48CMB-RG-DM	LED	6336 lm ( 36W)	PENDANT / CEILING	5	
D	6" LED RECESS DOWNLIGHT	JUNO	6RLD G4 10LM 30K 90CRI 120 FRPC WWH	LED	1000 lm (12W)	RECESS CEILING	4	
F	4" LED RECESS MINI CAN	JUNO	4RLD G4 O9LM 30K 90CRI 120 FRPC WWH	LED	600 lm (8W)	RECESS CEILING	-	
							-	
⊗	EXIT LIGHT	DUAL- LITE	EVEURWE (WITH BATTERY BACK-UP)	LED	INCLUDED	CEILING/VARIES	2	
44	EMERGENCY LIGHT	DUAL- LITE	EV4D (WITH BATTERY BACK-UP)	LED	INCLUDED	7'-6" A.F.F.	2	
4 <b>⊗</b> ₽	EXIT / EMERGENCY LT. COMBO	DUAL- LITE	EVCURWD4 (WITH BATTERY BACK-UP)	LED	INCLUDED	7'-6" A.F.F.	2	
EM	EXTERIOR EMERGENCY LIGHT	DUAL- LITE	PG Z-HTR (WITH BATTERY BACK-UP)	LED	INCLUDED	SURFACE OVER DOOR	2	
MOTEC.	<u>.                                      </u>	·			-			

GENERAL CONTRACTOR SHALL PROVIDE FIREPROOFING AROUND ANY RECESSED LIGHT FIXTURE INSTALLED IN A FIRE RATED CEILING PER U.L. REQUIREMENTS. ELECTRICAL CONTRACTOR SHALL COORDINATE.

- 2. EXIT AND EMERGENCY LIGHTS TO BE CONNECTED TO THE CIRCUIT AS NOTED, UN-SWITCHED.
- MANUFACTURERS LISTED IN THIS SCHEDULE OR BY WRITTEN ADDENDUM FROM THE ARCHITECT WILL BE THE ONLY APPROVED MANUFACTURERS TO BID THE LIGHTING FIXTURES IN THIS SCHEDULE. CONTRACTORS AND SUPPLIERS USING PRICING OR PHOTOMETRICS FROM MANUFACTURERS NOT LISTED ON SCHEDULE OR BY WRITTEN ADDENDUM DO SO AT THEIR OWN RISK.
- 4. PROVIDE BATTERY BACK-UP @ LOCATIONS SHOWN ON PLAN (EM).
- 5. VERIFY WITH ARCHITECT FOR FINAL HEIGHT PLACEMENT.

\$	SINGLE POLE SWITCH	PASS & SEYMOUR	PS20AC1-I	20A	125 / 277V	48" A.F.F. TO TOP	
\$3	THREE WAY SWITCH	PASS & SEYMOUR	PS20AC3-I	20A	125 / 277V	48" A.F.F. TO TOP	
\$D \$D3	DIMMER SWITCH	LUTRON	DVSTV	8A	125 / 277V	48" A.F.F. TO TOP	
Ф	DUPLEX RECEPT.	PASS & SEYMOUR	TR5362-I	20A	125V	16" A.F.F. TO BOTTOM	
8	G.F.I. DUPLEX RECEPT.	PASS & SEYMOUR	2094-TRI	20A	125V	16" A.F.F. TO BOTTOM	W/ TAYMAC # ML500G COVER PLATE
Ф	SINGLE GFCI RECEPTACLE	PASS & SEYMOUR	2097TRSGLW	20A	125V	16" A.F.F. TO BOTTOM	
<b>#</b>	RECEPT. / USB OUTLET	PASS & SEYMOUR	TR5362USB-I	20A	125V	16" A.F.F. TO BOTTOM	
0	NEMA-1 JUNCTION BOX	STEELCITY	4"x4" BOX			AS REQUIRED	
$\Diamond$	T.V. OUTLET	STEELCITY	2"x4" BOX			16" A.F.F. TO BOTTOM	WITH 1" C. TO ABOVE CLG.
<b>T</b>	TELEPHONE / DATA OUTLET	STEELCITY	2"x4" BOX			16" A.F.F. TO BOTTOM	WITH 1" C. TO ABOVE CLG.
(	THERMOSTAT	FURN. BY M.C.; INST. & O	CONN. BY E.C.			48" A.F.F. TO TOP	
•	MOTOR	FURN. & INST. BY M.C.;	CONN. BY E.C.			AS REQUIRED	
a,b,c	DENOTES SWITCH SCHEME						
1,3,5	DENOTES CIRCUIT NUMBERS						
\ \ \	3/4" CONDUIT WITH PULLWIRE					UNDER FLOOR	
/# \	BRANCH CIRCUIT	WITH NUMBER OF WIRES				UNDER FLOOR	
<b>_</b>	BRANCH CIRCUIT	WITH NUMBER OF WIRES				ABOVE FLOOR	
<b>_</b>	HOME RUN	WITH NUMBER OF WIRES				ABOVE FLOOR	
	COVED MANUFACTURERS OTHERS TO			-			

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	2	1	LO	
	2	-	LOAD	
DOOD		+	LIGHTING	
DOOR	2		RECEPTACLES (1ST	
			RECEPTACLES (REM	[
			LARGEST MOTOR	
		1	MOTORS	

#### ALL 120 VOLT CIRCUITS TO HAVE SEPARATE POWER NEUTRAL AND GROUND WIRES AS CALLED FOR IN

SURFACE MOUNTED

NEMA-1 ENCLOSURE

RATED AT 150 AMPS

FEEDER REQT'S

225 AMP MAIN L.O.

2 | 20/1

4 20/1

6 20/1

8 20/1

10 20/1

12 20/1

14 | 60/3

22 | 20/1

24 | 40/2

28 | 20/1

30 | 20/1

32 20/1

34 | 20/1

36 20/1

38 | 20/1

50

FEEDER SCHEDULE. SEE SHEET "E1.1" ⟨V⟩ FEEDER UP-SIZED FOR VOLTAGE DROP  $\langle G \rangle$  GFCI TYPE CIRCUIT BREAKER

CLES (REMAINING) 0 0.50 0 5.07 | 1.25 | 6.33 (ST) BREAKER WITH SHUNT TRIP

SPACE

SPACE

SPACE

SPACE

SPACE

0 1.00 0 37.79 0.65 24.56 MISC. EQUIPMENT (IO) LOCK ON CIRCUIT BREAKER 51.56 51.56

109.92 AMPS

CONNECTED KW | FACTOR | DEMAND KW

0 | 1.25 | 0

8.7 1.00 8.7

IF ALLOWED BY LOCAL CODE AUTHORITY, E.C. TO USE (1) 54 CIRCUIT SINGLE SECTION PANELBOARD. IF NOT, PANEL SHALL BE (1) 60 CIRCUIT, 2-SECTION, PANEL WITH COMMON TRIM AND CABINETS. SECTION-1 TO BE 30 CIRCUITS WITH FEED THRU LUGS. SECTION-2 TO BE 30 CIRCUITS WITH TOP FEED LUGS

	NEW PANEL "NA" LOCATED IN STORAGE ROOM 201
150	
	EXISTING 120/208V, 3Ø, 4W, 1600 AMP MAIN DISTRIBUTION SWITCHBOARD, LOCATED IN BASEMENT.  FIELD VERIFY EXACT LOCATION PRIOR TO ROUGH-IN.ELECTRICAL CONTRACTOR TO FURNISH AND INSTALL (1) NEW 150A, 3P, 208V CIRCUIT BREAKER IN
	THE AVAILABLE SPACE



F	EE	DEF	RSCHE	DUL	E		
FEEDER IDENT.	COP	PER CO	NDUCTORS	GROUND	ISOLATED	CONDUIT	
	CENTC	QUANT.	GWP.	SIZE	GRD. SIZE	SIZE	
(#)	SETS	PER SET	SIZE	PER SET	PER SET	PER SET	
20/1	1	2	#12 CU	#12 CU		1/2"	
40/2	1	2	#8 CU	#10 CU		1"	
60/2	1	2	#4 CU	#8 CU		1 1/4"	
150/N	1	4	#1/O CU	#6 CU		2"	
FEEDER IDENT.	ALU	MINUM (	CONDUCTORS	GROUND	ISOLATED	CONDUIT	
#	SETS	QUANT. PER SET	SIZE	PER SET	GRD. SIZE PER SET	SIZE PER SET	
150/N	1	4	#3/O AL	#4 AL		2"	

SPECIAL OUTLET SCHEDULE

DESCRIPTION

RECESSED TV BOX WITH (2) DUPLEX RECEPTACLE. (2) CAT 6 DATA AND (1) COAX

LOCATION WITH ARCHITECTS/OWNER PRIOR TO ROUGH-IN.

DESCRIPTION

 $\langle G \rangle$  1 | EQUIP.  $\bigcirc$  1

 $\langle G \rangle | 3 | EQUIP. \overline{3}$ 

 $\langle G \rangle | 5 | EQUIP. (3)$ 

 $\langle G \rangle | 7 | EQUIP. (3)$ 

 $\langle G \rangle | 9 | EQUIP. (3)$ 

 $\langle G \rangle | 13 | EQUIP.$  (14)

15 RECEPTS.

17 RECEPTS.

19 RECEPTS.

21 RECEPTS.

23 BOOTH RECEPTS.

25 BOOTH RECEPTS.

27 BOOTH RECEPTS.

29 PAY KIOSK

 $\langle G \rangle | 31 | EQUIP.$  (

 $\langle G \rangle | 37 | RECEPT.$ 

 $\langle G \rangle$  39 | EQUIP.

 $\langle G \rangle | 33 | EQUIP.$  12

 $\langle G \rangle | 35 | EQUIP.$  15

41 SPACE

43 SPACE

45 SPACE

47 SPACE

49 SPACE

51 SPACE

53 SPACE

CLES (1ST 10KVA)

AMPS @ 120/208 VOLT, 3Ø, 4W, 60 Hz

TOTAL:

LOAD SUMMARY

 $\langle G \rangle$  11 | EQUIP. (

CABLE CONNECTOR EQUAL TO ARLINGTON RECESS STEEL TV BOX # TVBS507 3 GANG. PROVIDE EXTENDERS AND SPLITTERS AS REQUIRED. COORDINATE MOUNTING

PANEL "NA"

120/208V, 3Ø, 4W, SN

0.8 20

0.8

A B C KW DESCRIPTION

1.08 EQUIP. (5)

1.56 - 1.17 EQUIP. 4

1.56 - 1.4 EQUIP. (

1.56 00 1.2 EQUIP. (11

1.56 00 1.2 EQUIP. (11)

1.56 1.2 EQUIP. (11)

1.56 20 14.1 EQUIP. (10)

1.2 20 60 1.0 ELECT. FIREPLACE

1.2 1.0 ELECT. FIREPLACE

0.8 OO 1.2 POWER BLINDS

0.3 O 1.2 POWER BLINDS

1.2 POWER BLINDS

1.92 POWER BLINDS

1.5 | 1.2 | RECEPTS.

SYMBOL

BREAKERS TO HAVE

MIN. 10,000 AIC

SERIES RATED


TYPE SQ-D NQ

FEEDER REQT'S

20/1


- 1. IF APPROVED BY LOCAL CODE AUTHORITY, E.C. HAS THE OPTION TO USE ALUMINUM CONDUCTORS FOR ANY BRANCH FEEDER 100 AMPERES OR MORE, EXCEPT FOR ELEVATOR BRANCH FEEDERS WHICH ARE TO BE COPPER,
- ALUMINUM CONDUCTORS SHALL BE XHHW2 (90°) COMPACT STRANDED CONDUCTORS.




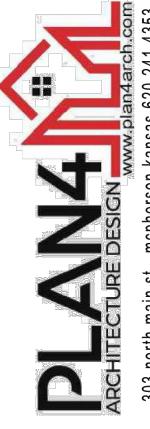

22

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Contract Date	
Rev No. 1	
Rev No. 2	
Rev No. 3	
Rev No. 4	
Rev No. 5	
Rev No. 6	
Project Number:	22.31
DWG File	
Designed By:	CRS
Drawn By:	JAW
Approved By:	plan4
Contract Date  Rev No. 1  Rev No. 2  Rev No. 3  Rev No. 6  Rev No. 6  Project Number:  DWG File  Designed By:  Drawn By:  Approved By:  Date:	03/25/2024

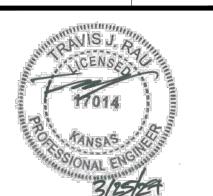

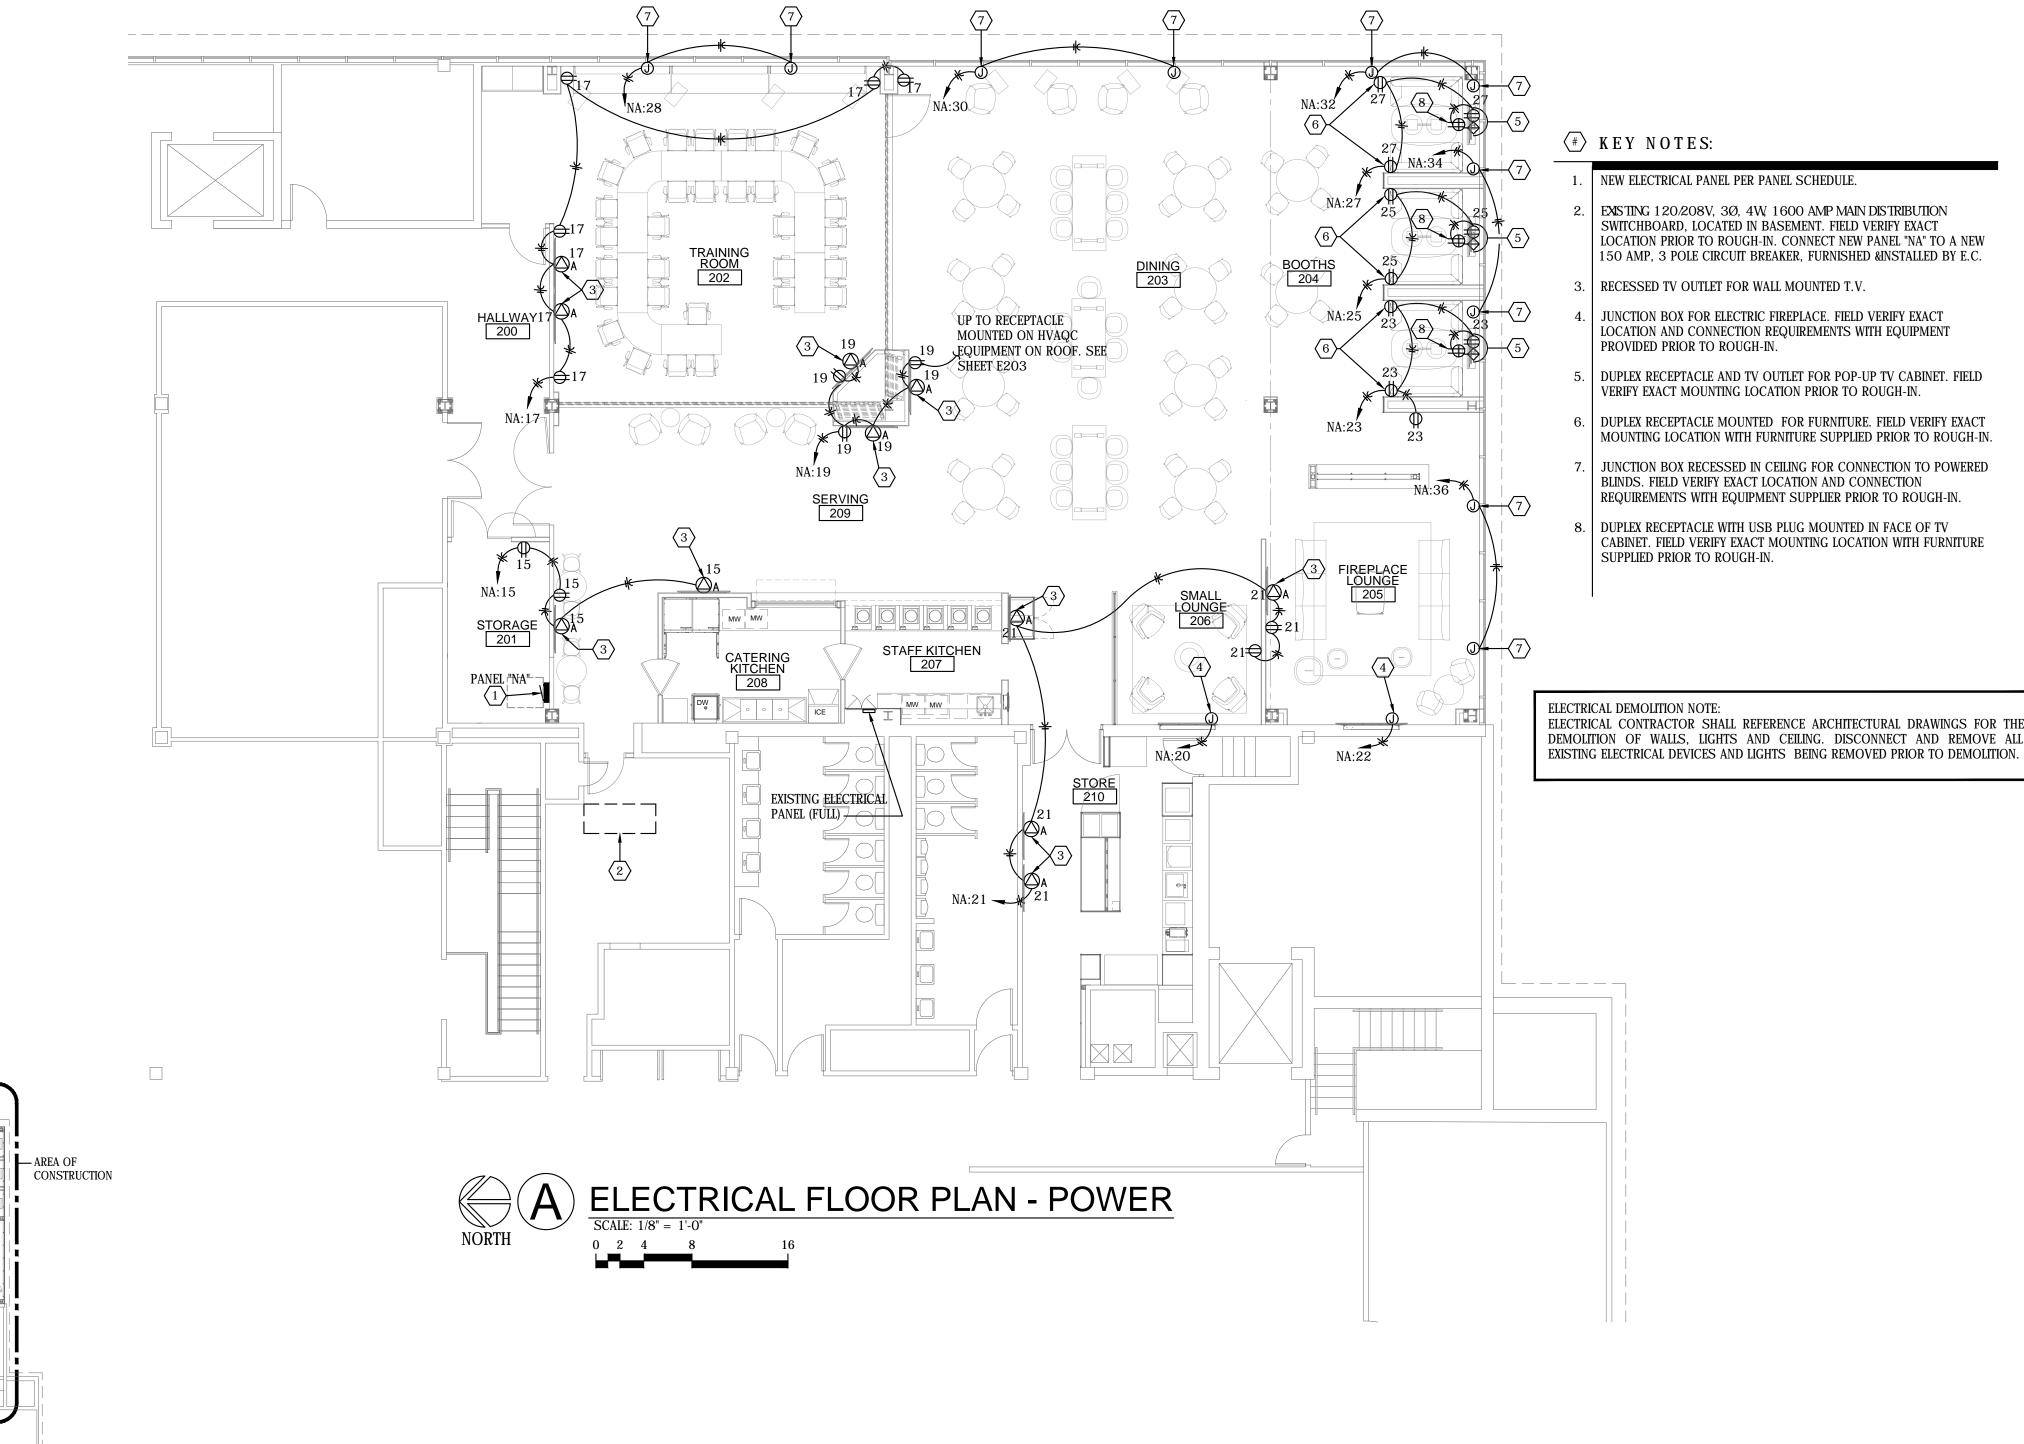

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- SWITCHBOARD, LOCATED IN BASEMENT. FIELD VERIFY EXACT LOCATION PRIOR TO ROUGH-IN. CONNECT NEW PANEL "NA" TO A NEW
- JUNCTION BOX FOR ELECTRIC FIREPLACE. FIELD VERIFY EXACT LOCATION AND CONNECTION REQUIREMENTS WITH EQUIPMENT
- DUPLEX RECEPTACLE AND TV OUTLET FOR POP-UP TV CABINET. FIELD
- DUPLEX RECEPTACLE MOUNTED FOR FURNITURE. FIELD VERIFY EXACT
- REQUIREMENTS WITH EQUIPMENT SUPPLIER PRIOR TO ROUGH-IN.
- DUPLEX RECEPTACLE WITH USB PLUG MOUNTED IN FACE OF TV CABINET. FIELD VERIFY EXACT MOUNTING LOCATION WITH FURNITURE

DEMOLITION OF WALLS, LIGHTS AND CEILING. DISCONNECT AND REMOVE ALL

SHEET NUMBER

Contract Date

Rev No. 2

Rev No. 3

Rev No. 25

Project Number:

DWG File

Designed By:

Approved By:

Drawn By:


JAW

E201

67460

BUILDING KEY PLAN

NOT TO SCALE

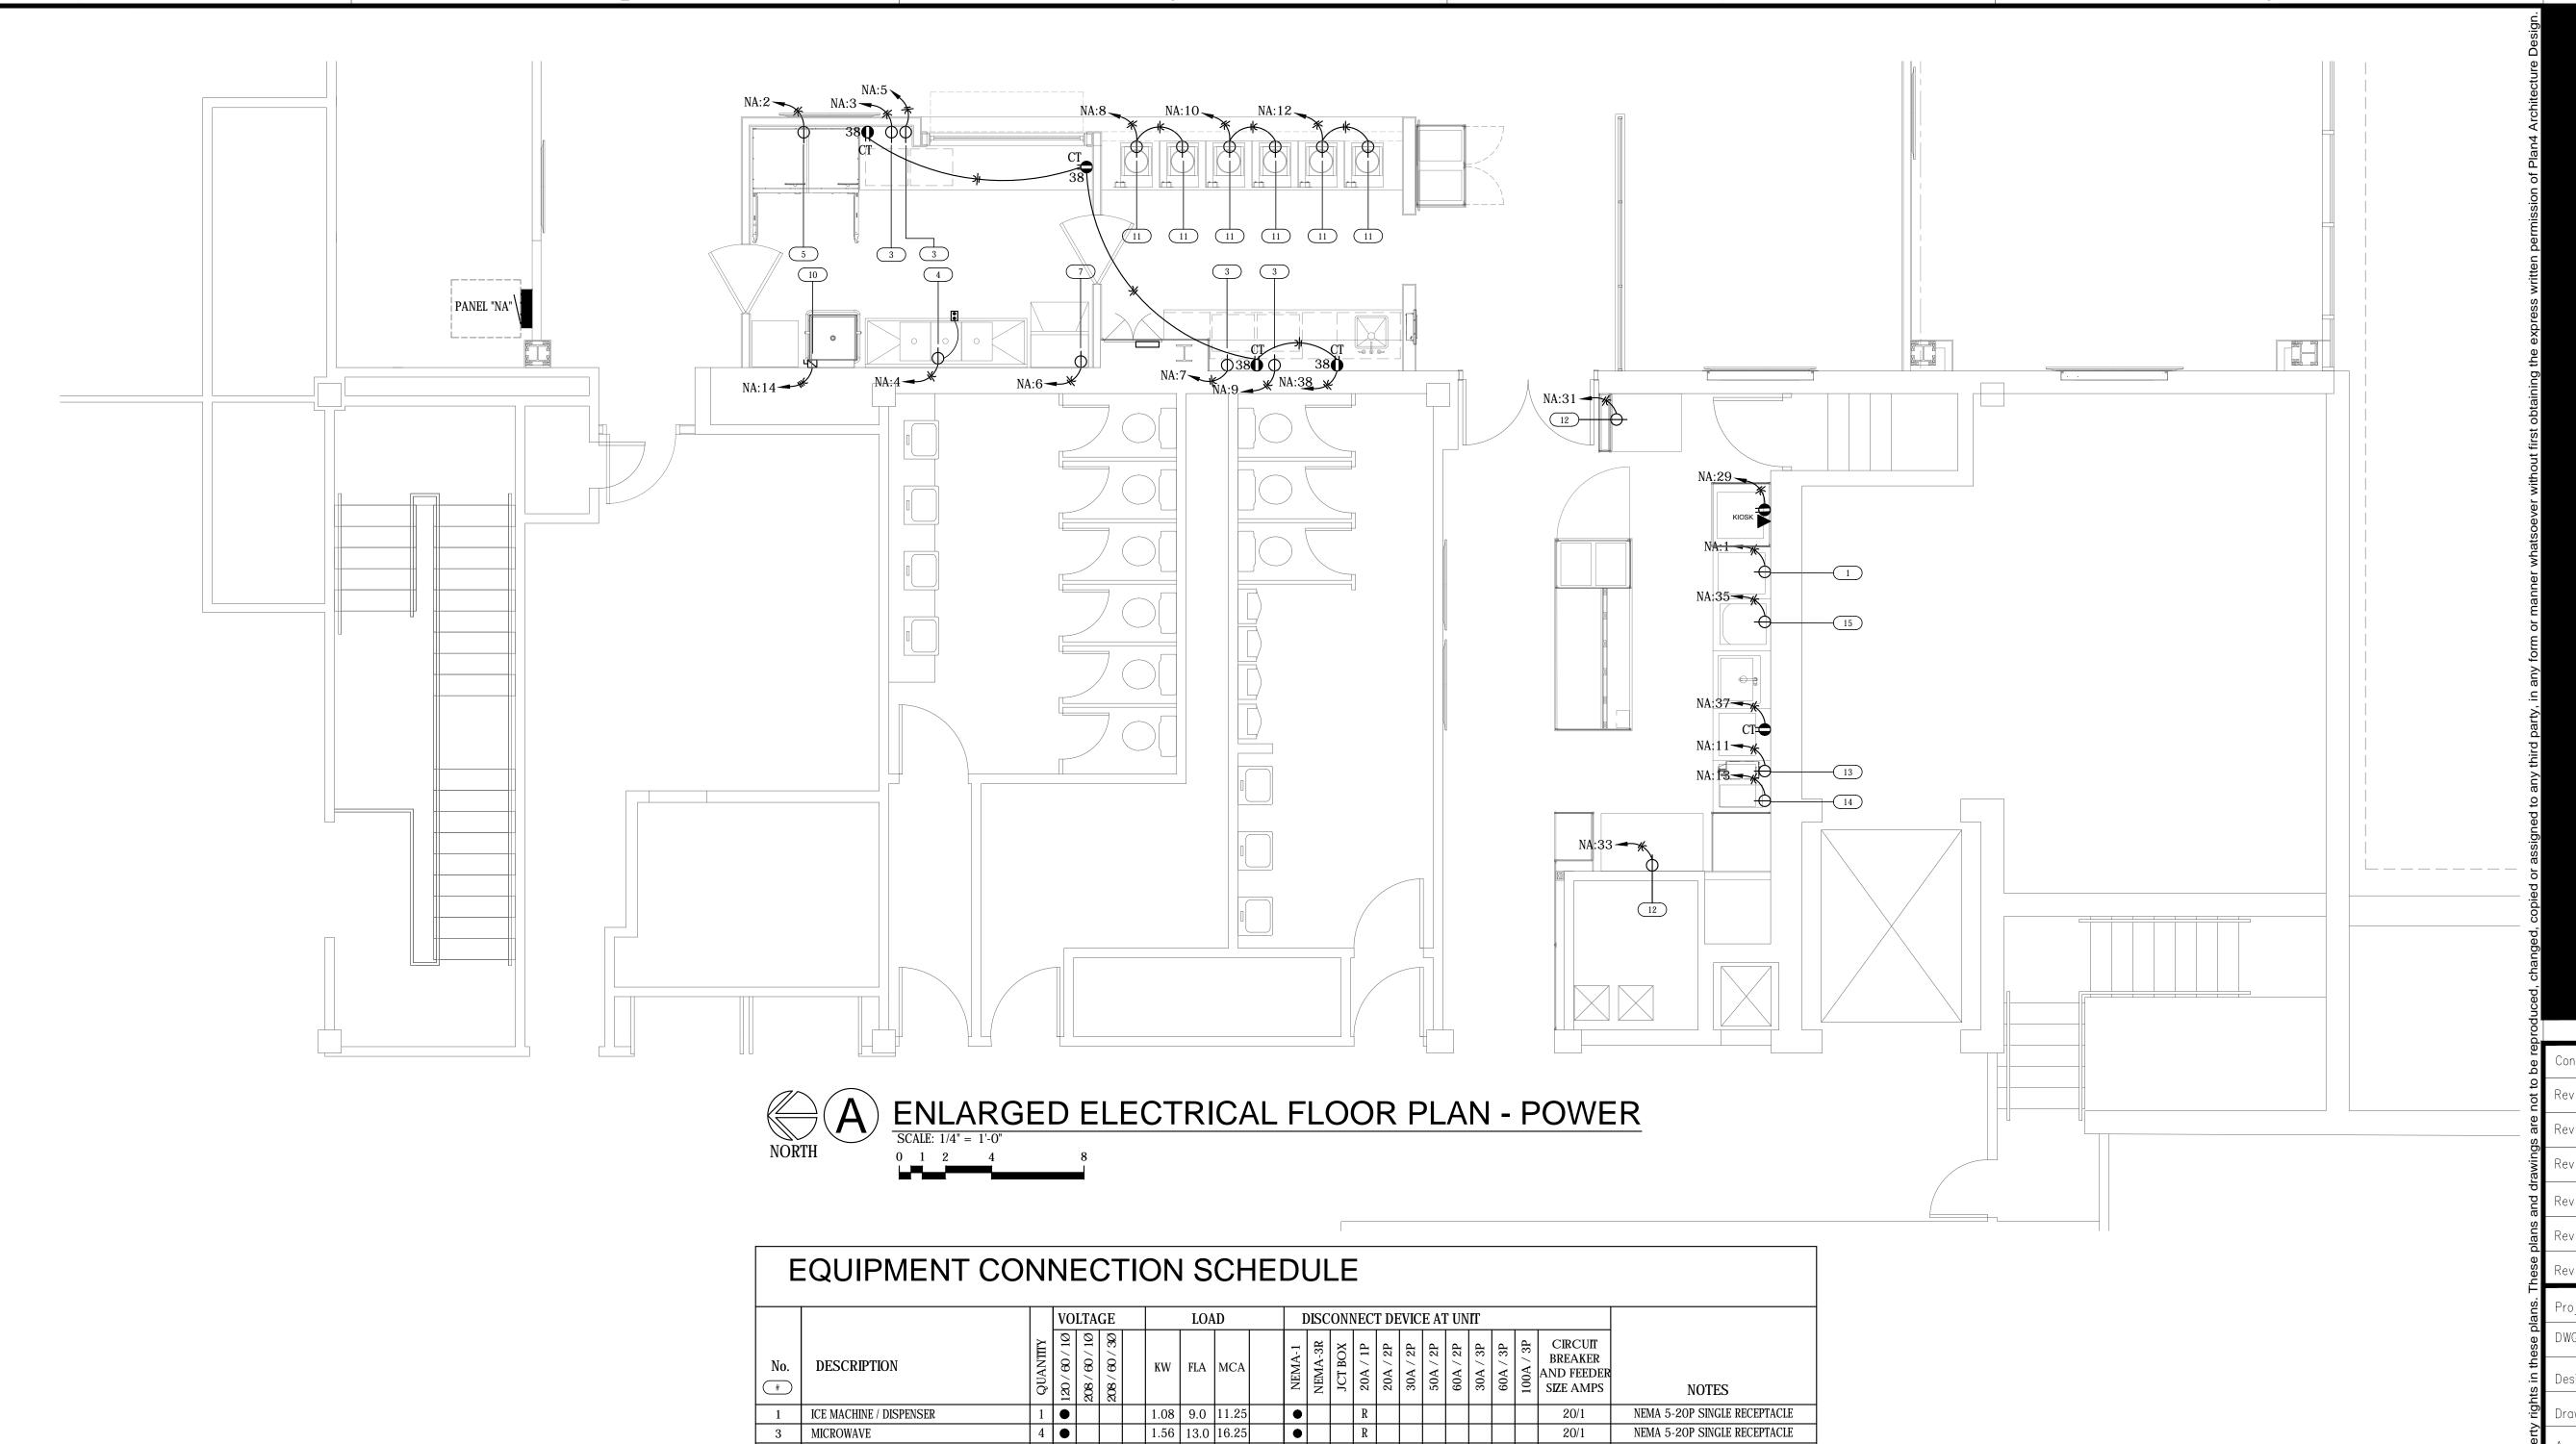

			1		~-																
				LTA			LOA	ND D	l	DISC	ONN	VEC.	L DF	VIC	E A'I	' UN	ΙΤ				
No.	DESCRIPTION	QUANTITY	120 / 60 / 10	208 / 60 / 10	208 / 60 / 30	KW	FLA	MCA	NEMA-1	NEMA-3R	JCT BOX	20A / 1P	20A / 2P	30A / 2P	50A / 2P	60A / 2P	30A / 3P	60A / 3P	100A / 3P	CIRCUIT BREAKER AND FEEDER SIZE AMPS	NOTES
1	ICE MACHINE / DISPENSER	1	•			1.08	9.0	11.25	•			R								20/1	NEMA 5-20P SINGLE RECEPTACLE
3	MICROWAVE	4	•			1.56	13.0	16.25	•			R								20/1	NEMA 5-20P SINGLE RECEPTACLE
4	DISPOSAL	1	•			1.17	9.8	12.25	•			R								20/1	NEMA 5-20P SINGLE RECEPTACLE
5	UPRIGHT REACH-IN DUAL TEMPS	1	•			1.08	9.0	11.25	•			R								20/1	NEMA 5-20P SINGLE RECEPTACLE
7	ICE MAKER, UNDERCOUNTER	1	•			1.4	11.44	14.3	•			R								20/1	NEMA 5-20P SINGLE RECEPTACLE
10	HIGH TEMP. DISHWASHER	1			•	14.1	39.2	49.0	•		•							SW		60/3	VERIFY DISCONNECT REQUIREMENTS
11	INDUCTION WARMER	6	•			0.6	5.0	6.25	•			R								20/1	NEMA 5-20P SINGLE RECEPTACLE
12	REFRIGERATOR	2	•			1.2	10.0	12.5	•			R								20/1	NEMA 5-20P SINGLE RECEPTACLE
13	COFFEE BREWER	1	•			1.44	12.0	15.0	•			R								20/1	NEMA 5-20P SINGLE RECEPTACLE
14	TEA BREWER	1	•			1.44	12.0	15.0	•			R								20/1	NEMA 5-20P SINGLE RECEPTACLE
15	COFFEE MACHINE	1	•			1.92	16.0	20.0	•			R								20/1	NEMA 5-20P SINGLE RECEPTACLE

#### EQUIPMENT NOTES

- 1. ALL KITCHEN EQUIPMENT ELECTRICAL REQUIREMENTS AND CONNECTIONS ARE DESIGNED ACCORDING TO INFORMATION PROVIDED AT TIME OF DESIGN. THE ELECTRICAL CONTRACTOR SHALL FIELD VERIFY ALL ELECT. LOADS, LOCATIONS, CONNECTION, AND PLUG CONFIGURATION REQUIREMENTS WITH EQUIPMENT SUPPLIER PRIOR TO ROUGH-IN. IN THE EVENT THAT THE EQUIPMENT PROVIDED DIFFER FROM THE FINAL DRAWINGS IT IS THE RESPONSIBILITY OF THE EQUIP. SUPPLIER / INSTALLER TO PROVIDE THE ELECTRICAL CONTRACTOR WITH THESE CHANGES.
- 2. ALL SWITCHES, TIMECLOCKS, RELAYS, TRANSFORMERS, ETC, SHALL BE FURNISHED AND INSTALLED BY THE ELECTRICAL CONTRACTOR. FIELD VERIFY WITH MECHANICAL DESIGNER AND MECHANICAL DRAWINGS FOR ADDITIONAL INFORMATION.
- 3. PER N.E.C. 210.8 ALL 120V/1Ø, 208V/1Ø, AND 208V,3Ø RECEPTACLES LOCATED IN THE KTICHEN SHALL BE PROTECTED BY A GFCI TYPE CIRCUIT BREAKER IN THE PANEL, UNLESS OTHERWISE NOTED.

SYMBOL KEY
TS - TOGGLE SWITCH
SW - FUSIBLE SWITCH
R - STANDARD RECEPTACLE
G - GFCI RECEPTACLE
M - MOTOR STARTER SWITCH
J - JUNCTION BOX, VERIFY
DISCONNECT MEANS






Farmers Alliance Mutual Insur 1122 North Main

Contract Date	
Rev No. 1	
Rev No. 2	
Rev No. 3	
Rev No. 4	
Rev No. 5	
Rev No. 6	
Project Number:	22.31
	22.31
Project Number:	22.31 CRS
Project Number: DWG File	
Project Number:  DWG File  Designed By:	CRS
Project Number:  DWG File  Designed By:  Drawn By:	CRS JAW



SHEET NUMBER

E202

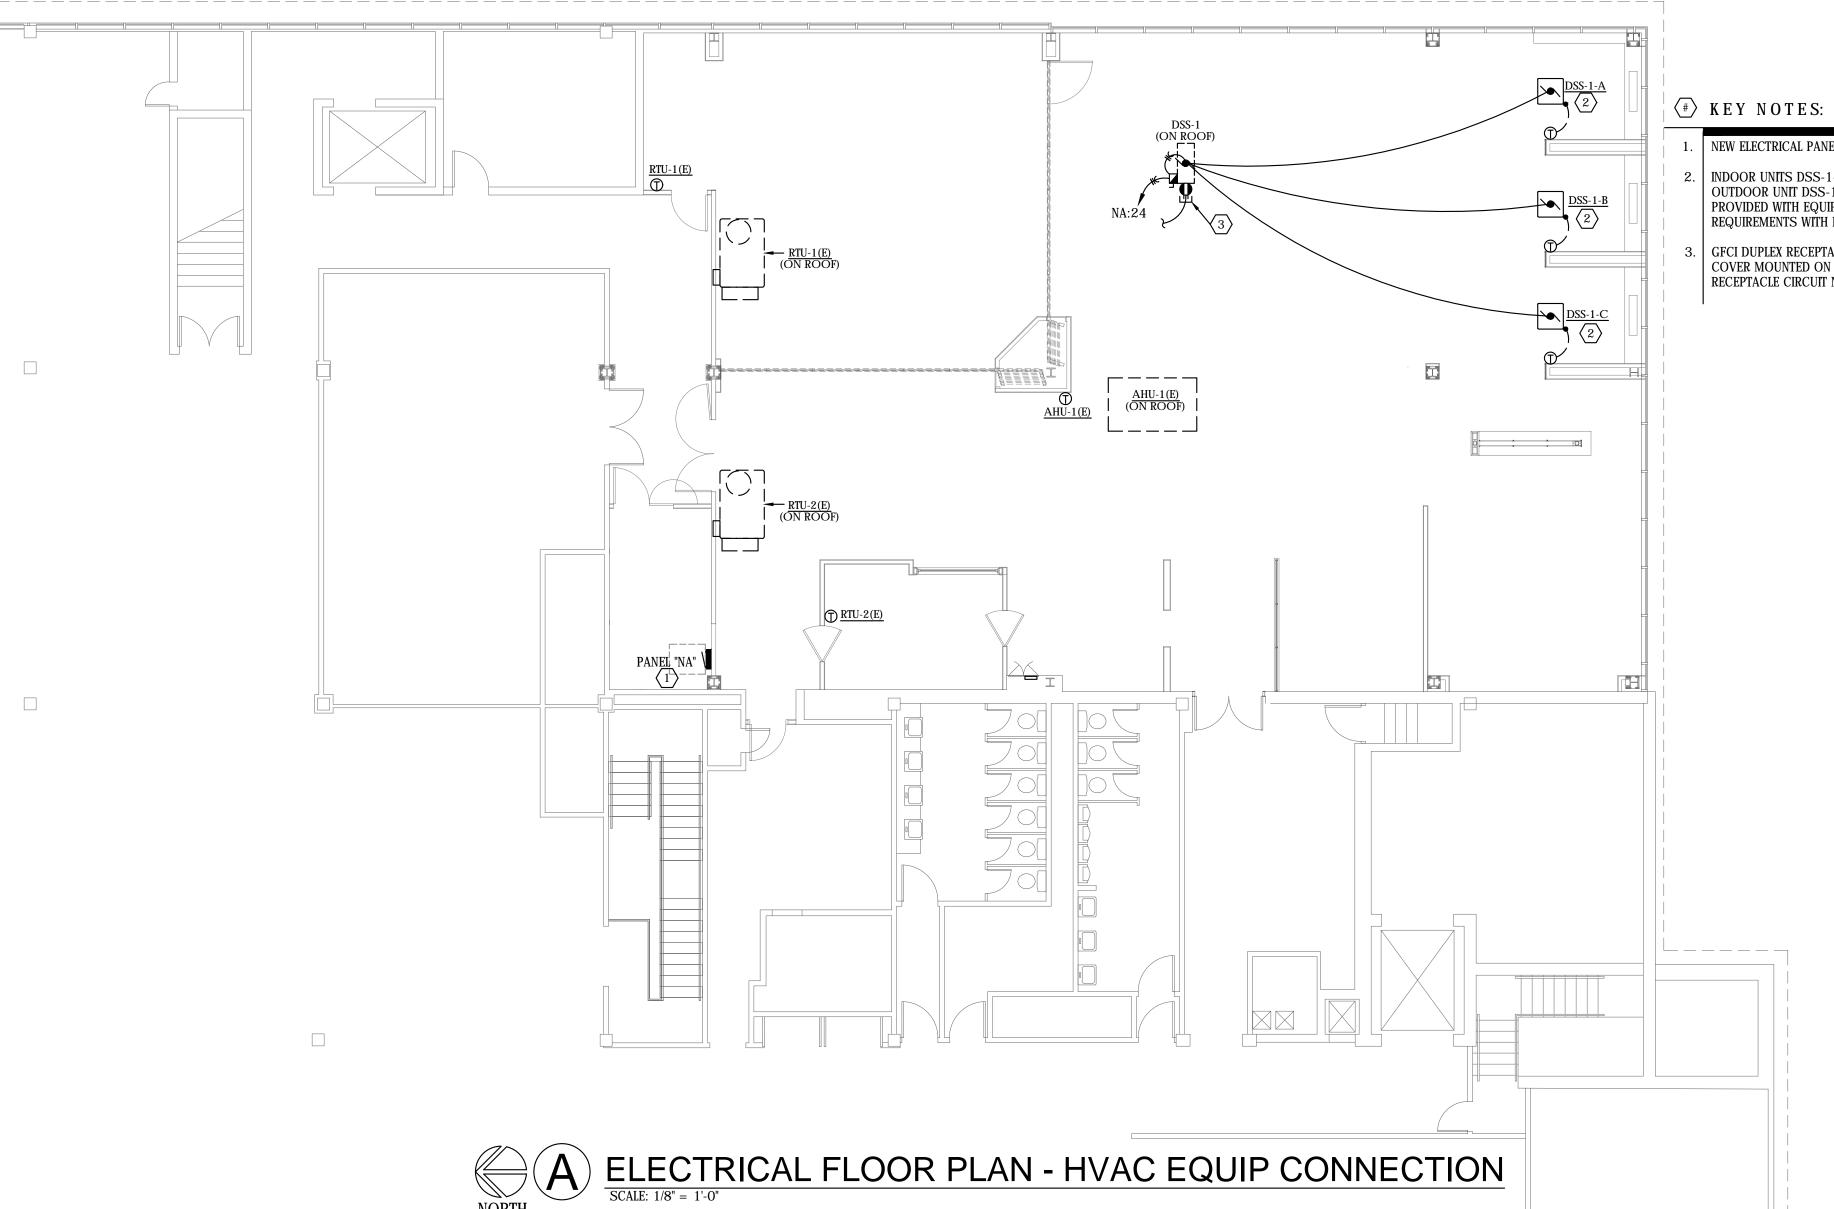


NEW ELECTRICAL PANEL PER PANEL SCHEDULE.

INDOOR UNITS DSS-1-A, DSS-1-B, DSS-1-C ARE POWERED TO OUTDOOR UNIT DSS-1 MOUNTED ON THE ROOF VIA POWER CABLE PROVIDED WITH EQUIPMENT. E.C. TO FIELD VERIFY EXACT CONNECTION REQUIREMENTS WITH EQUIPMENT PROVIDED PRIOR TO ROUGH-IN.

GFCI DUPLEX RECEPTACLE IN NEMA-3R BOX WITH WEATHERPROOF COVER MOUNTED ON EQUIPMENT. CONNECT TO THE 120 VOLT RECEPTACLE CIRCUIT NA:19 BELOW.

> Contract Date Rev No. 2 Rev No. 3 Rev No. 5 Project Number: DWG File Designed By: Drawn By:

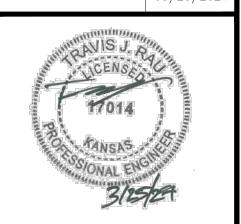


SHEET NUMBER

Approved By:

E203

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# KEY NOTES:

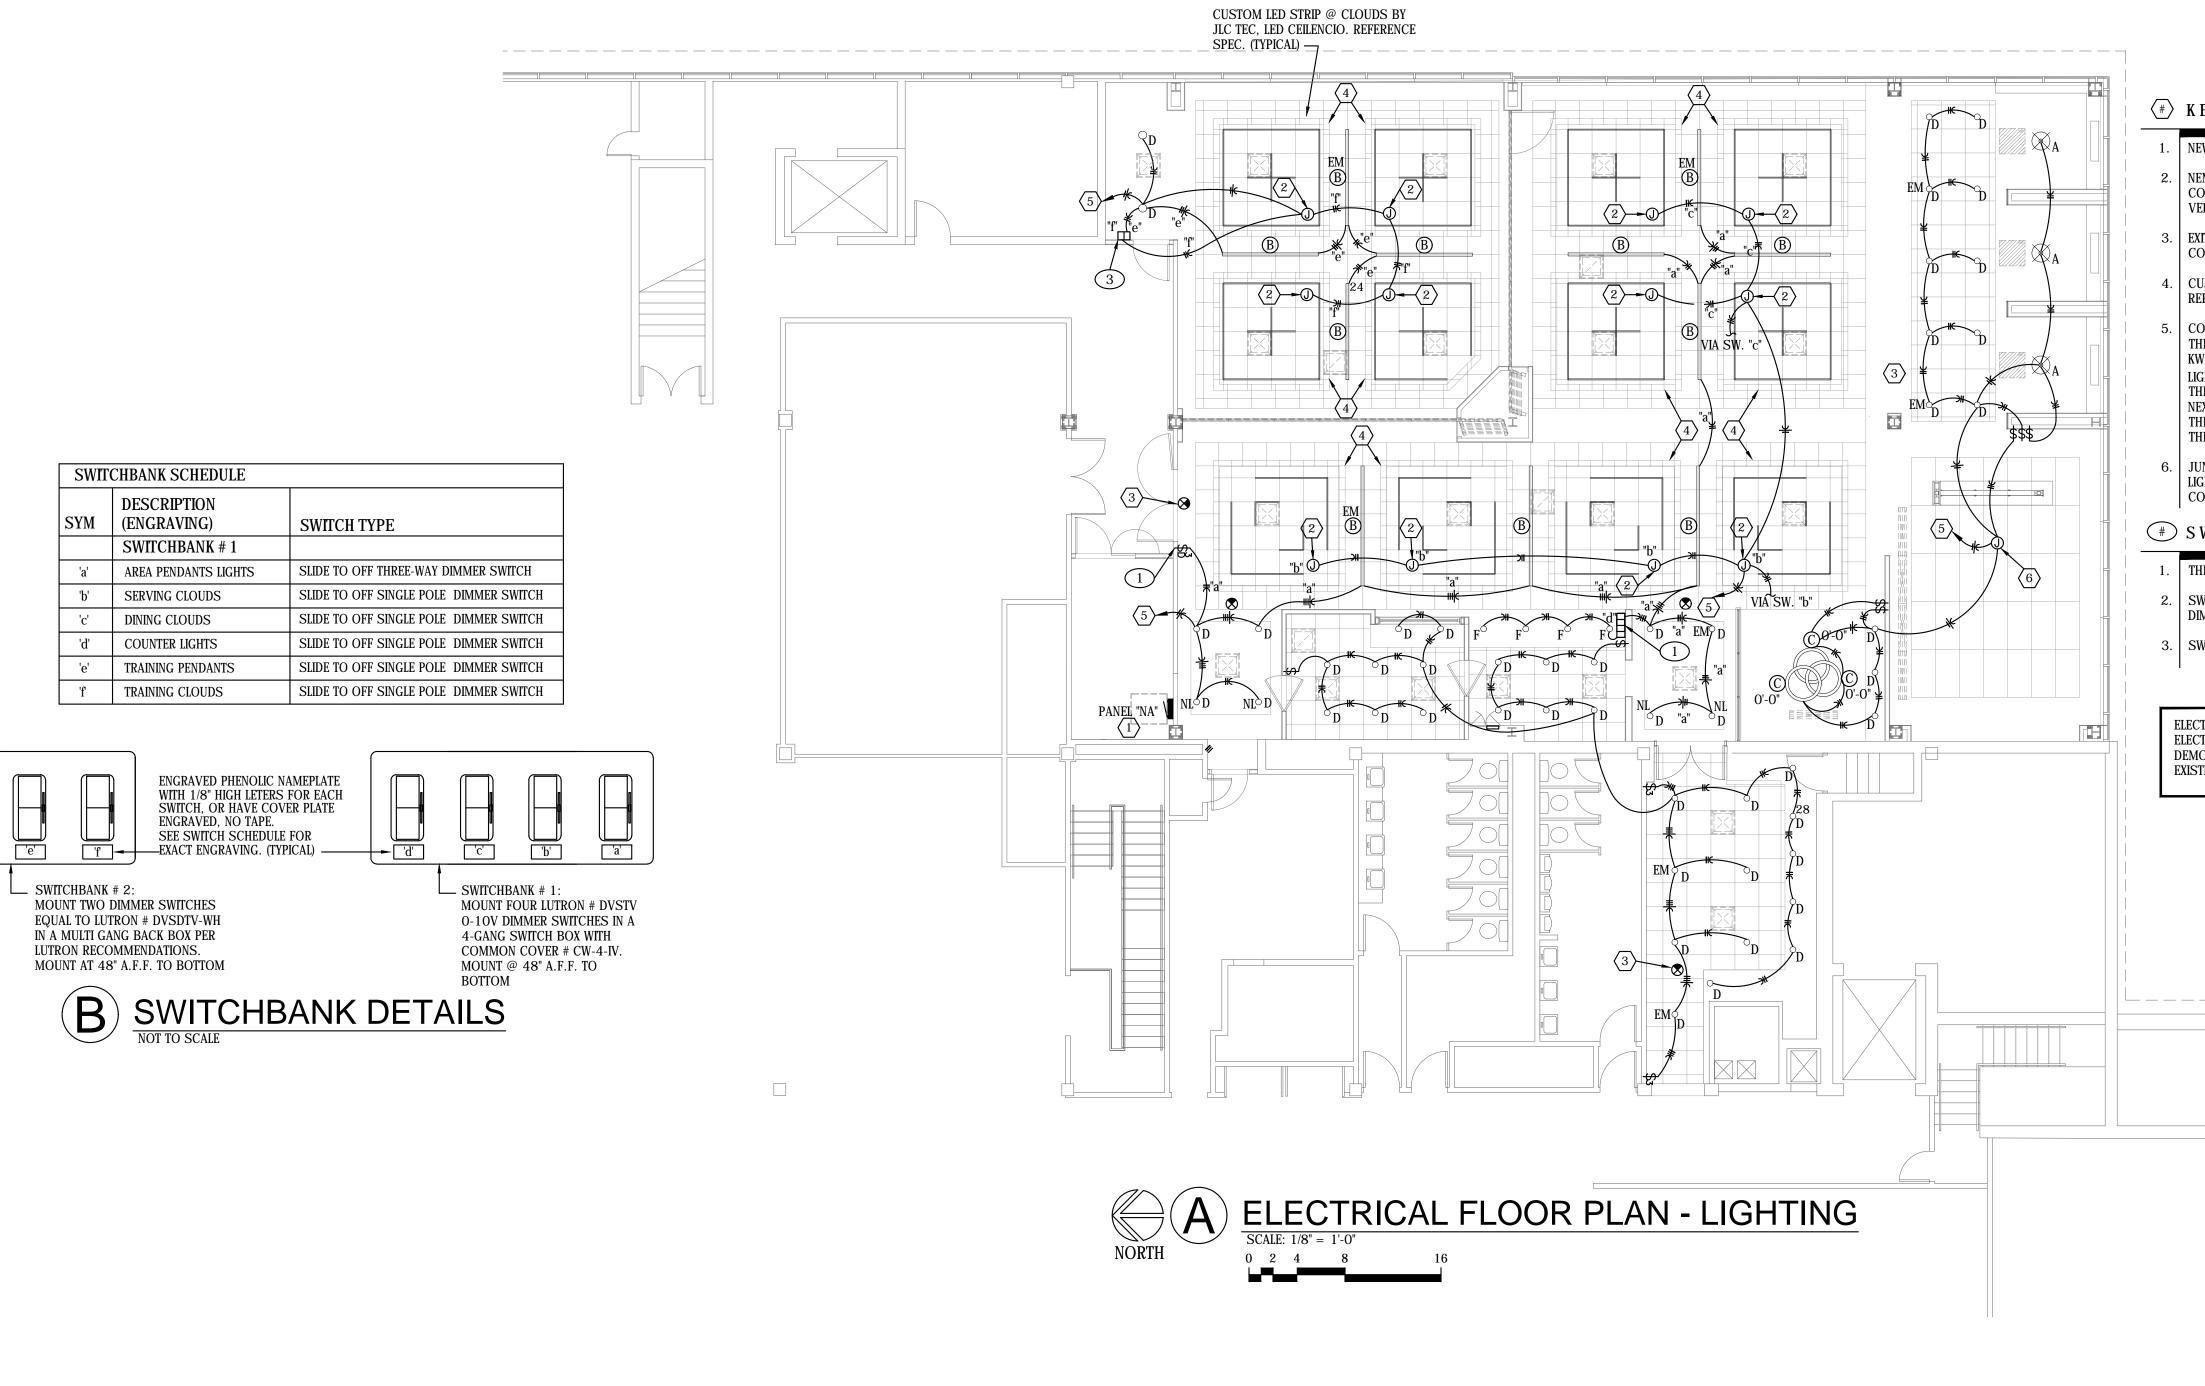1. NEW ELECTRICAL PANEL PER PANEL SCHEDULE.

NEMA-1 JUNCTION BOX MOUNTED ABOVE DROP CLOUD CEILING FOR CONNECTION TO THE LED CUSTOM FIXTURES IN THE CLOUD. FIELD VERIFY EXACT CONNECTION REQUIREMENTS PRIOR TO ROUGH-IN.

EXIT LIGHT AND LIGHT FIXTURES EMERGENCY BATTERY BACK-UP TO BE CONNECTED TO THE LIGHTING CIRCUIT IN THE AREA UN-SWITCHED.

4. CUSTOM LED STRIP @ CLOUDS BY JLC TEC, LED CEILENCIO. REFERENCE SPEC.

CONNECT TO THE EXISTING 277V LIGHTING CIRCUIT IN THE AREA IF THE EXISTING CIRCUIT IN THE AREA HAS THE CAPACITY TO INCLUDE 2.5 KW OF ADDITIONAL LIGHTING AFTER THE DEMOLITION OF EXISTING LIGHTS, WITH 2 No. 12 THHN & 1 No. 12 GROUND IN ½" CONDUIT. IF THERE IS NO CAPACITY ON THE EXISTING CIRCUIT, CONNECT TO THE NEXT AVAILABLE SPACE OR SPARE 20A, 277V LIGHTING CIRCUIT IN THE EXISTING 277/480V PANEL. FURNISH & INSTALL A NEW BREAKER IN THE EXISTING PANEL IF NO SPARE IS PRESENT.

6. JUNCTION BOX ABOVE CEILING FOR THE "ARKTURA VAPOR VERVE" LIGHTED CEILING SYSTEM. FIELD VERIFY EXACT LOCATION AND CONNECTION REQUIREMENTS WITH INSTALLED PRIOR TO ROUGH-IN.

# SWITCH NOTES:

1. THREE-WAY DIMMER SWITCH "a",

2. SWITCHBANK # 1; THREE-WAY DIMMER SWITCH "a", SINGLE POLE DIMMER SWITCHES "b" & "c".

3. SWITCHBANK # 2; SINGLE POLE DIMMER SWITCHES "d", & "e".

ELECTRICAL DEMOLITION NOTE:

ELECTRICAL CONTRACTOR SHALL REFERENCE ARCHITECTURAL DRAWINGS FOR DEMOLITION OF WALLS, LIGHTS AND CEILING. DISCONNECT AND REMOVE EXISTING ELECTRICAL DEVICES AND LIGHTS BEING REMOVED PRIOR TO DEMOLITI

Rev No. 2

Rev No. 4

Rev No. 6

Rev No. 6

Project Number: 22.31

DWG File

Designed By: CRS

Drawn By: JAW

Approved By: plan4

Date: 03/25/2024

Contract Date



SHEET NUMBER

E301

ENGINUITY

CONSULTING ENGINEERS LLC

111 N MOSLEY, SUITE 200, WICHITA, KS 67202
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ARCHITECTURE DESIGN WWW.plan4arch.com

THE CONTRACT DRAWINGS FOR DIVISION 16 WORK ARE IN PART SCHEMATIC, INTENDED TO CONVEY THE SCOPE OF WORK AND INDICATE THE GENERAL LAYOUT, DESIGN AND ARRANGEMENT. THE CONTRACTOR SHALL FOLLOW THESE DRAWINGS IN THE LAYOUT OF HIS WORK AND SHALL CONSULT GENERAL INTENT CONSTRUCTION DRAWINGS, STRUCTURAL DRAWINGS, MECHANICAL DRAWINGS AND ALL OTHER DRAWINGS FOR THIS PROJECT TO DETERMINE ALL CONDITIONS AFFECTING THE DIVISION 16 WORK.

WHERE SPECIFIC DETAILS AND DIMENSIONS FOR DIVISION 16 WORK ARE NOT SHOWN ON THE DRAWINGS, THE CONTRACTOR SHALL TAKI MEASUREMENTS AND MAKE LAYOUTS AS REQUIRED FOR THE PROPER INSTALLATION OF THE WORK AND COORDINATION WITH ALL OTHER WORK ON THE PROJECT. IN CASE OF ANY DISCREPANCIES BETWEEN THE DRAWINGS AND THE SPECIFICATIONS THAT HAVE NOT BEEN CLARIFIED BY ADDENDUM PRIOR TO BIDDING, IT SHALL BE ASSUMED BY THE SIGNING OF THE CONTRACT THAT THE HIGHER COST IS

THIS WORK SHALL INCLUDE ALL PLANT, LABOR, MATERIAL AND EQUIPMENT AS REQUIRED TO FURNISH AND INSTALL DIVISION 16 WORK INCLUDING DEMOLITION AS SHOWN ON THE DRAWINGS AND AS HEREINAFTER SPECIFIED. FURNISH AND INSTALL ALL MATERIALS, EQUIPMENT, DEVICES AND ACCESSORIES NOT SPECIFICALLY CALLED FOR BY ITEM BUT THAT ARE NECESSARY TO PROVIDE THE requirements in operation and function that is established by the design and by the equipment specified.

WORK TO INCLUDE THE PROCUREMENT OF AND PAYMENT OF ALL PERMITS AND LICENSES REQUIRED FOR THE PERFORMANCE OF THE WORK. WORK TO INCLUDE ALL FEES AND DIRECT EXPENSES INVOLVED IN ANY INSPECTIONS REQUIRED FOR THE PROJECT. ALL SCAFFOLDS, STAGING, RUNWAYS AND EQUIPMENT REQUIRED FOR THE PERFORMANCE OF THE WORK. THE REMOVAL FROM THE PREMISES, AS IT ACCUMULATES, OF ALL DIRT AND REFUSE RESULTING IN THE PERFORMANCE OF THE WORK.

16010.03 - PROTECTION AND DUST CONTROL THE CONTRACTOR SHALL PROVIDE ADEQUATE PROTECTION TO PREVENT DAMAGE TO ADJACENT AREAS, EQUIPMENT, OR FURNISHINGS; TO PREVENT ACCIDENTAL INJURY TO THE BUILDING OCCUPANTS AND THE PUBLIC; TO PREVENT THE SPREADING OF DUST, DIRT, DEBRIS, AND MOISTURE FROM GETTING ON OR IN THE BUILDING OCCUPANTS FURNISHINGS OR EQUIPMENT.

16010.04 - FXISTING CONDITIONS EACH BIDDER SHALL INSPECT THE SITE AS REQUIRED FOR KNOWLEDGE OF EXISTING CONDITIONS AND FAILURE TO OBTAIN SUCH KNOWLEDGE SHALL NOT RELIEVE THE SUCCESSFUL BIDDER OF THE RESPONSIBILITY TO MEET THE EXISTING CONDITIONS IN PERFORMING

WHERE EXISTING POWER, LIGHTING OR CONTROL CIRCUITRY IS BROKEN BY REMOVAL OF EXISTING DEVICES, EQUIPMENT OR FIXTURES, OR BY DEMOLITION WORK, CUTTING OR REMOVAL OF EXISTING BUILDING CONSTRUCTION, AND WHERE THE EXISTING CIRCUITRY IS REQUIRED BY REMAINING DEVICES OR EQUIPMENT TO STAY IN SERVICE, THEN THE CIRCUITRY SHALL BE COMPLETED AS REQUIRED BY JOB

16010.05 - MATERIAL AND MANUFACTURE ALL MATERIAL AND EQUIPMENT SHALL BE NEW EXCEPT AS STATED OTHERWISE; SHALL BE OF THE BEST QUALITY AND DESIGN; SHALL BE FREE FROM DEFECTS AND IMPERFECTIONS AND SHALL HAVE MARKINGS OR A NAMEPLATE IDENTIFYING THE MANUFACTURER AND PROVIDING SUFFICIENT REFERENCE TO ESTABLISH QUALITY, SIZE AND CAPACITY.

16010.06 - SUBSTITUTIONS ALL PRODUCTS PROPOSED FOR USE, INCLUDING THOSE SPECIFIED BY REQUIRED ATTRIBUTES AND PERFORMANCE, SHALL REQUIRE APPROVAL BY THE ENGINEER BEFORE BEING INCORPORATED INTO THE WORK.

WHERE THE PHRASE "OR EQUAL" OR "APPROVED EQUAL" OCCURS IN THE CONTRACT DOCUMENTS, DO NOT ASSUME THAT MATERIALS, EQUIPMENT OR METHODS WILL BE APPROVED AS EQUAL UNLESS THE ITEM HAS BEEN SPECIFICALLY APPROVED FOR THIS WORK BY THE

16010 07 - SAFFTY REGULATIONS ALL DIVISION 16 WORK SHALL BE PERFORMED IN COMPLIANCE WITH ALL APPLICABLE AND GOVERNING SAFETY REGULATIONS OF THE

16010.08 - CODES, ORDINANCES, REGULATIONS AND U.L. APPROVAL

ALL DIVISION 16 WORK SHALL CONFORM TO THE REQUIREMENTS OF ALL APPLICABLE CODES, ORDINANCES AND REGULATIONS INCLUDING THE CURRENT RULES AND REGULATIONS OF THE NATIONAL ELECTRICAL CODE, THE NATIONAL FIRE PROTECTION ASSOCIATION, OSHA AND ALL STATE AND LOCAL LAWS, CODES AND ORDINANCES.

FIXTURES, APPLIANCES, EQUIPMENT AND MATERIALS WHICH ARE SUBJECT TO UNDERWRITERS LABORATORY TESTS SHALL BEAR SUCH

WHERE OPENINGS ARE MADE, OR LEFT DUE TO CONSTRUCTION THROUGH FIRE RATED ASSEMBLIES FOR CONDUIT OR NIPPLES, FOR SLEEVES CONTAINING CABLE OR WIRE, AND OPEN CONDUITS THROUGH FIRE RATED ASSEMBLIES THE AREA AROUND THE OPENINGS, SLEEVES AND CONDUITS SHALL BE FILLED WITH CHASE TECHNOLOGY CORP. #CTCPF-855 OR DOW CORNING #3-6548 RTV SILICONE OR APPROVED EQUAL, FIRE RESISTANT FOAM SEALANT AS APPROVED BY THE AUTHORITY HAVING JURISDICTION

ALL OPENINGS IN THE ROOF FOR ELECTRICAL CONDUITS SHALL BE MADE WEATHER AND WATER TIGHT USING "STONEMAN" MULTI-FLASH OR VERSA-FLASH SEAMLESS FLASHING ASSEMBLY FOR CONDUIT THROUGH 2" DIAMETER. CONDUIT SIZES OVER 2" DIAMETER SHALL HAVE PITCH POCKETS FILLED WITH PITCH AND GALVANIZED DRIP SHIELD INSTALLED AROUND CONDUITS. THE DRIP SHIELD SHALL

16010.11 - EXCAVATION AND BACK FILLING PERFORM ALL EXCAVATING AND BACK FILLING FOR THE CONSTRUCTION AND INSTALLATION OF THE WORK INCLUDED UNDER THIS DIVISION. LINES SHALL BE USED TO LAYOUT THE TRENCHES FOR ALL UNDERGROUND WORK. TRENCHES CLOSE TO WALLS,

FOUNDATIONS, AND COLUMNS SHALL NOT BE EXCAVATED WITHOUT PRIOR CONSULTATION WITH THE ENGINEER/ARCHITECT. ALL EXCAVATIONS SHALL BE PROPERLY PROTECTED BY THE NECESSARY BRACING AND TIMBERS TO PREVENT ANY CAVE-INS OR INJURY

CUT AND REPLACE ALL EXISTING WALKS, ROADS, STREET PAVEMENT, CURBS, STEPS, RETAINING WALLS AND MISCELLANEOUS WORK

THE BACK FILLING OF TRENCHES SHALL BE CARRIED OUT AS RAPIDLY AS THE FINISHED WORK IS APPROVED AND WILL PERMIT. THE TRENCH SHALL BE BACK FILLED IN LAYERS NOT TO EXCEED 6" WITH GOOD SELECTED DRY EARTH THOROUGHLY TAMPED WITH A PNEUMATIC TAMPER. AFTER BACK FILLING, ALL SURPLUS EXCAVATED MATERIAL SHALL BE REMOVED FROM THE SITE.

16010.12 - SHOP DRAWINGS AND SAMPLES SUBMIT FOR APPROVAL A PDF SET OF MANUFACTURER'S SHOP DRAWINGS OF ALL MAJOR ITEMS OF EQUIPMENT AND ALL ITEMS REQUIRING COORDINATION BETWEEN CONTRACTORS. ACCEPTANCE OF THE WORK SHALL BE SUBJECT TO THE ENGINEERS/ARCHITECTS. APPROVAL OF SHOP DRAWINGS, PRODUCT DATA AND SAMPLES. SHOP DRAWINGS SHALL INCLUDE MANUFACTURERS DETAIL DRAWINGS OF EQUIPMENT AND MATERIAL AND CONTRACTORS SHOP DETAILS FOR INSTALLATION OF MATERIAL AND EQUIPMENT. DESCRIPTIV LITERATURE SHALL INCLUDE CATALOG DATA COVERING DESIGN, SIZE AND CAPACITY OF MATERIAL AND EQUIPMENT. SUBMITTALS SHALL INCLUDE THE MANUFACTURERS MODEL NUMBER, CAPACITY, PERFORMANCE DATA, ELECTRICAL CHARACTERISTICS, ETC., ALL CLEARLY SHOWN AND MARKED FOR THE SPECIFIC ITEM OF EQUIPMENT BEING FURNISHED ON THIS PROJECT

THE CONTRACTOR SHALL KEEP DAY-TO-DAY RECORD OF ALL CHANGES OR VARIATIONS MADE FROM THE CONTRACT DOCUMENTS AND AT THE END OF THE PROJECT SHALL PROVIDE THE OWNER/ARCHITECT/ENGINEER WITH REPRODUCIBLE SETS AS REQUESTED.

16010.14 - WIRING OF MECHANICAL EQUIPMENT FURNISH AND INSTALL ALL POWER WIRING, AND ALL CONTROL AND INTERLOCK WIRING OF ALL UNITS, PUMPS, FANS, WATER HEATERS, ETC. CONNECT PER MANUFACTURER'S WIRING DIAGRAMS. FURNISH AND INSTALL ALL NECESSARY DISCONNECT SWITCHES REQUIRED.

AFTER INSTALLATION OF THE CONTROL INTERLOCK WIRING, THE CONTRACTOR SHALL VERIFY THAT EACH MOTOR LOAD HAS THE CORRECT PHASE ROTATION. THIS CONTRACTOR SHALL VERIFY THE ACTUAL WIRE SIZING AMPS FOR MECHANICAL EQUIPMENT FROM THE EQUIPMENT NAMEPLATE, ELECTRICAL INSTALLATION SHALL BE BASED ON ACTUAL REQUIRED AMPERAGES, WHICH MAY VERY SOMEWHAT FROM THE WIRE AND EQUIPMENT SIZES SHOWN ON THE DRAWINGS. PROPERLY SIZED ELECTRICAL WIRING AND EQUIPMENT SHALL BE FURNISHED WITHOUT EXTRA COST TO THE CONTRACT. THE CONTRACTOR SHALL NOTIFY THE ENGINEER OF ALL CHANGES TO BE MAD IN THE ELECTRICAL INSTALLATION DUE TO EQUIPMENT VARIANCES THAT THE IMPACT ON FEEDERS, PANELS, FUSE AND BREAKER SIZES CAN BE CHECKED PRIOR TO THE INSTALLATION.

16010.15 - WRING OF THERMOSTATS AND TEMPERATURE CONTROLS
FURNISH AND INSTALL ALL POWER WIRING, AND ALL CONTROL AND INTERLOCK WIRING OF ALL THERMOSTATS AND TEMPERATURE
CONTROL DEVICES INCLUDING NIGHTSTATS, TIME SWITCHES, OVERRIDE TIMERS, ETC. SEE MECHANICAL DRAWINGS FOR LOCATIONS AND TEMPERATURE CONTROL DIAGRAMS.

16010.16 - TELEPHONE SYSTEM PROVISIONS ELECTRICAL CONTRACTOR TO FIELD VERIFY WITH LOCAL SERVICE PROVIDER FOR THE EXACT REQUIREMENTS TO BRING SERVICE TO THIS PROJECT. PROVIDE AND INSTALL FLUSH MOUNTED TELEPHONE OUTLET BOXES WITH 1" CONDUIT STUB UP CONCEALED TO ACCESSIBLE CEILING SPACE AT LOCATIONS AS SHOWN ON THE DRAWINGS.

16010.17 - DATA SYSTEM PROVISIONS. PROVIDE AND INSTALL FLUSH MOUNTED DATA OUTLET BOXES WITH 1" CONDUIT STUB UP CONCEALED TO ACCESSIBLE CEILING SPACE AT LOCATIONS AS SHOWN ON THE DRAWINGS.

ALL ELECTRICAL EQUIPMENT ON THIS PROJECT FURNISHED UNDER THIS DIVISION AND ALL ELECTRICAL EQUIPMENT FURNISHED BY OTHERS SHALL BE ADJUSTED, ALIGNED AND TESTED FOR PROPER OPERATION BY THE ELECTRICAL CONTRACTOR. COMPLETE WIRING CIRCUITS SHALL BE FREE FROM SHORT CIRCUITS. ALL MOTORS SHALL BE VERIFIED FOR PROPER PHASE ROTATION. THE CONTRACTOR SHALL PROVIDE TEST DATA READINGS AS REQUESTED OR AS NOTED. THE CONTRACTOR SHALL HAVE THE FOLLOWING READILY ACCESSIBLE AT ALL TIMES DURING THIS PROJECT: A TRUE RMS READING VOLTMETER, A TRUE RMS READING AMMETER, AND A MEGGER INSULATION RESISTANCE METER.

16010.19 - OPERATION AND MAINTENANCE INSTRUCTIONS SUBMIT TO THE ARCHITECT THREE COPIES EACH OF MATERIAL FOR MAINTENANCE AND OPERATION INSTRUCTION MANUALS, APPROPRIATELY BOUND INTO MANUAL FORM INCLUDING APPROVED COPIES OF THE FOLLOWING, REVISED IF NECESSARY TO SHOW SYSTEM AND EQUIPMENT AS ACTUALLY INSTALLED: MANUFACTURER'S CATALOG SHEETS, WIRING DIAGRAMS, MAINTENANCE INSTRUCTIONS, OPERATING INSTRUCTIONS, PARTS LIST. CONTRACTOR SHALL ALSO PROVIDE ADEQUATE VERBAL INSTRUCTIONS OF SYSTEM OPERATION TO OWNER'S REPRESENTATIVE AT THE TERMINATION OF THE WORK.

16010.20 - STARTUP OF SYSTEMS PRIOR TO STARTUP OF THE ELECTRICAL SYSTEMS, THE CONTRACTOR SHALL CHECK ALL COMPONENTS AND DEVICES, LUBRICATE ITEMS ACCORDINGLY, AND TIGHTEN ALL SCREWED AND BOLTED CONNECTIONS. ADJUST TAPS ON EACH TRANSFORMER FOR RATED SECONDARY VOLTAGE. CHECK SERVICE ENTRANCE VOLTAGE, GROUNDING CONDITIONS, GROUNDING RESISTANCE AND PROPER PHASING. BALANCE SINGLE PHASE LOADS AT EACH PANELBOARD, REDISTRIBUTING BRANCH CIRCUIT CONNECTIONS UNTIL BALANCE IS ACHIEVED. AFTER ALL SYSTEMS HAVE BEEN INSPECTED AND ADJUSTED, CONFIRM ALL OPERATING FEATURES REQUIRED BY THE DRAWINGS AND SPECIFICATIONS AND MAKE FINAL ADJUSTMENTS AS NECESSARY.

GUARANTEE AGAINST WORKMANSHIP AND MATERIAL FOR A PERIOD OF ONE YEAR FROM DATE OF FINAL PAYMENT. GUARANTEE SHALL INCLUDE MATERIAL TO BE REPLACED AND ALL LABOR REQUIRED.

16014 - ELECTRICAL IDENTIFICATION

16014.01 - DESCRIPTION OF WORK PROVIDE AND INSTALL REQUIRED IDENTIFICATION FOR THE SYSTEMS AND EQUIPMENT SHOWN ON THE DRAWINGS AND/OR SPECIFIED. UNDERGROUND PLASTIC LINE MARKER: MANUFACTURERS STANDARD PERMANENT, BRIGHT-COLORED, CONTINUOUS-PRINTED PLASTIC TAPE, FOR DIRECT BURIAL SERVICE; MINIMUM 6" WIDE X 4 MILS THICK. PRINTING TO INDICATE TYPE OF SERVICE CABLE; WITH LARGE (MINIMUM 2-1/2") HIGH LETTERS.

CABLE/CONDUCTOR IDENTIFICATION BANDS: MANUFACTURERS STANDARD VINYL SELF-ADHESIVE SELF LAMINATING CABLE/CONDUCTOR MARKERS, WRAP AROUND TYPE; PRE-NUMBERED PLASTIC COATED, OR WRITE-ON TYPE WITH CLEAR PLASTIC SELF-ADHESIVE COVER FLAP, LETTERING TO SHOW CIRCUIT IDENTIFICATION. SIMILAR TO PANDUIT "INSTACODE" OR ACCEPTED EQUIVALENT BY T&B OR TYTON. SELF-ADHESIVE PLASTIC SIGNS: MANUFACTURERS STANDARD, SELF ADHESIVE, PRE-PRINTED, FLEXIBLE VINYL SIGNS FOR OPERATIONAL INSTRUCTIONS OR WARNINGS.

DANGER SIGNS: MANUFACTURERS STANDARD "DANGER" SIGNS, BAKED ENAMEL FINISH ON 20 GAUGE STEEL; STANDARD RED, BLACK AND WHITE GRAPHICS.

INSTALLATION OF RACEWAY SYSTEMS FOR ALL WORK IN DIVISION 16 INCLUDING REQUIRED FITTINGS AND SUPPORTS.

ALL CONDUCTORS SHALL BE INSTALLED IN METALLIC CONDUIT UNLESS SPECIFIED.

ALL CONDUIT SHALL BE ELECTRICAL METALLIC TUBING (EMT), EXCEPT CONDUIT LARGER THAN 4" DIAMETER, CONDUIT OUTDOORS OR IN WET OR DAMP LOCATIONS, OR IN NEC CLASSIFIED HAZARDOUS LOCATIONS, CONDUIT IN EARTH OR BELOW GRADE, AND EXCEPT AS OTHERWISE NOTED ON THE DRAWINGS OR SPECIFIED OTHERWISE.

ELECTRICAL METALLIC TUBING TO BE THREADLESS, STEEL TYPE CONFORMING TO ANSI STANDARD C80.3, NEC 348, AND UL 797, GALVANIZED INSIDE AND OUT.

ALL EMT FITTINGS TO BE COMPRESSION TYPE UNLESS OTHERWISE NOTED.

ALL UNDERGROUND CONDUIT SHALL BE RIGID. ENCASE EACH UNDERGROUND CONDUIT IN CONCRETE AS INDICATED ON THE DRAWINGS. SHORT SECTIONS OF FLEXIBLE CONDUIT (GREENFIELD) SHALL BE USED FROM JUNCTION OR OUTLET BOXES TO LIGHTING FIXTURES AS PERMITTED BY THE NATIONAL ELECTRICAL CODE. CONNECTIONS FROM OUTLET BOXES ABOVE CEILINGS TO FLUORESCENT FIXTURES RECESSED IN CEILING SHALL BE MADE WITH FLEXIBLE METALLIC STEEL CONDUIT NOT TO EXCEED 6 FEET IN LENGTH. FINAL CONNECTIONS TO MOTORS, TRANSFORMERS, AND TO ANY PIECE OF EQUIPMENT THAT WILL TRANSMIT MOTION, NOISE OR VIBRATION SHALL BE FLEXIBLE METAL CONDUIT. FLEXIBLE CONDUIT SHALL NOT BE INSTALLED OUTDOORS OR IN DAMP LOCATIONS. ALL FLEXIBLE CONDUIT IN DENTAL SPACE SHALL BE HCF TYPE.

LIQUID TIGHT FLEXIBLE STEEL CONDUIT SHALL BE USED WHEN MAKING CONNECTIONS IN THE FOLLOWING CONDITIONS: EXPOSED TO LIQUIDS, EXPOSED TO VAPORS, EXPOSED TO SUNLIGHT.

CONDUITS SHALL BE RUN PARALLEL AND PERPENDICULAR TO BUILDING LINES AND SHALL BE RUN AGAINST THE STRUCTURE IN A NEAT

CONDUIT SHALL BE INSTALLED CONCEALED ABOVE SUSPENDED CEILINGS OR CONCEALED IN WALLS OR FLOORS WHEREVER POSSIBLE. CONDUIT SHALL BE INSTALLED TO CLEAR ALL OPENINGS, DEPRESSIONS, PIPES, DUCTS, REINFORCING STEEL, ETC. ALL CONDUIT SHALL BE RAN OVERHEAD. CONDUIT SHALL BE RAN CONTINUOUS BETWEEN CONNECTIONS TO OUTLET BOXES AND CABINETS WITH MINIMUM POSSIBLE NUMBER OF BENDS. RADIUS OF BENDS SHALL BE AS LONG AS POSSIBLE AND NEVER SHORTED THAN THE CORRESPONDING TRADE ELBOW. LONG RADIUS ELBOWS SHALL BE USED WHERE NECESSARY. CONDUITS SHALL BE SECURELY FASTENED IN PLACE WITH APPROVED STRAPS, HANGERS AND STEEL SUPPORTS AS REQUIRED. SINGLE CONDUITS FOR FEEDERS SHALL BE HUNG WITH MALLEABLE SPLIT RING HANGERS WITH ROD AND TURNBUCKLE SUSPENSION FROM INSERTS SPACED NOT OVER 10 FEET APART FROM CONSTRUCTION ABOVE. GROUPS OF HORIZONTAL FEEDER CONDUITS SHALL BE CLAMPED TO UNISTRUT STEEL CHANNELS AND SUSPENDED FROM INSERTS NOT SPACED OVER 10 FEET APART IN CONSTRUCTION ABOVE. HORIZONTAL FEEDER CONDUITS SHALL BE CLAMPED TO STRUCTURAL STEEL MEMBERS ATTACHED TO THE STRUCTURE. CABLE CLAMPS SHALL BE INSTALLED FOR SUPPORT OF VERTICAL FEEDERS WHERE REQUIRED. CONDUIT SUPPORTS SHALL BE ADDED WITHIN 12" AT ONE END OF ALL BENDS. CONDUIT SHALL NOT BE SUSPENDED FROM SUSPENDED CEILING COMPONENTS.

CONDUIT ENDS SHALL BE REAMED BEFORE INSTALLATION AND ALL CONDUIT SHALL BE THOROUGHLY CLEANED BEFORE INSTALLATION AND KEPT CLEAN AFTER INSTALLATION. PLUG CONDUIT AND BOXES AS REQUIRED DURING CONSTRUCTION TO KEEP CONDUIT CLEAN. CONDUIT SHALL BE OF AMPLE SIZE TO PULL CONDUCTORS AND NOT SMALLER THAN THE CODE REQUIRED. MINIMUM SIZE CONDUIT

WHERE BUILDING EXPANSION JOINTS ARE SHOWN ON THE DRAWINGS PROVIDE PROPER CONDUIT EXPANSION FITTING.

CONDUIT SEALS SHALL BE INSTALLED ON ALL CONDUITS PASSING FROM NON-COOLED TO COOLED SPACES AND IN ALL CONDUIT PENETRATIONS OF FREEZER AND COOLER WALLS. SEALS SHALL CONSIST OF PLIABLE COMPOUND RATED FOR -20 DEGREES F. TO 100 DEGREES F. FURNISH AND INSTALL THE NECESSARY JUNCTION BOXES, COUPLINGS, SUPPORTS, ADAPTERS, ETC. TO FORM A COMPLETE

INSTALL A PULL WIRE IN EACH EMPTY CONDUIT WHICH IS LEFT BY THE CONTRACTOR.

ALL CONDUITS AND/OR SURFACE RACEWAYS SHALL BE PAINTED WHERE INSTALLED EXPOSED IN FINISHED SPACES. PAINTING OF SURFACE RACEWAYS SHALL BE AS DIRECTED BY THE ENGINEER/ARCHITECT.

16120 - CONDUCTORS (LOW VOLTAGE, 600 VOLTS)

SHALL BE 1/2" FOR THIS PROJECT.

16120.01 - DESCRIPTION OF WORK FURNISH AND INSTALL 600 VOLT CONDUCTORS AND ASSOCIATED SPLICES, CONNECTORS AND TERMINATION'S FOR LIGHTING, POWER AND AUXILIARY SYSTEMS AS SHOWN ON THE CONTRACT DOCUMENTS.

98% CONDUCTIVITY COPPER. NEC TYPE THHN/THWN (90 C DRY/75 C WET) WITH UL LABEL. ALL CONDUCTORS TO BE IN CONDUIT SINGLE CONDUCTOR, STRANDED (ALL SIZES), SOFT ANNEALED COPPER CONDUCTORS WITH 600 VOLT THERMOPLASTIC INSULATION AND

WIRE SMALLER THAN #12 GAUGE SHALL NOT BE USED UNLESS OTHERWISE SPECIFIED ON THE DRAWINGS OR IN THESE SPECIFICATIONS.

WIRE INSULATION SHALL BE COLOR COATED AS FOLLOWS OR PER LOCAL ORDINANCES: 120/208V, 3Ø – A-BLACK, B-RED, C-BLUE, NEUTRAL-WHITE, G-GREEN. 277/480V, 3ø – A-BROWN, B-ORANGE, C-BLUE, NEUTRAL-GRAY, G-GREEN.

BLACK INSULATION IS ACCEPTABLE FOR #8 WIRE AND LARGER. CONDUCTOR ENDS SHALL BE WRAPPED WITH COLORED TAPE AS

IF NO WRE SIZE IS INDICATED ON THE DRAWINGS FOR A BRANCH CIRCUIT, PROVIDE #12 AWG WIRE AND A 20A CIRCUIT BREAKER.
CONTROL WIRING SHALL HAVE 600V INSULATION AND BE OF THE PROPER TYPE, SIZE AND NUMBER REQUIRED TO ACCOMPLISH SPECIFIED

16120.03 - INSTALLATION ALL WRING SHALL BE INSTALLED IN APPROVED RACEWAYS OR ENCLOSURES. WIRE IN CONDUIT SHALL RAN CONTINUOUS WITHOUT SPICES OR TAPS. ALL SPLICES OR TAPS SHALL OCCURS IN APPROVED BOXES AND ENCLOSURES AND SHALL BE KEPT TO A MINIMUM, AND SHALL BE MADE WITH APPROVED SOLDERLESS CONNECTIONS. ALL SPLICES, TAPS AND JOINTS SHALL BE INSULATED PER THE ATIONAL ELECTRICAL CODE. ALL MATERIALS USED TO TERMINATE, SPLICE OR TAP CONDUCTORS SHALL BE DESIGNED FOR, PROPER SIZE FOR, AND UL LISTED FOR THE SPECIFIC APPLICATION AND CONDUCTORS INVOLVED, AND SHALL BE IN STRICT ACCORDANCE WITH THE MANUFACTURER'S RECOMMENDATIONS. USING THE MANUFACTURER'S RECOMMENDED TOOLS.

WHERE WIRE IS TO BE INSTALLED, BUT THE CONNECTION IS INDICATED "FUTURE" OR "BY OTHERS", THE CONTRACTOR SHALL PROVIDE A MINIMUM OF 3 FEET OF "PIGTAIL" AT THE BOX. TAPE ALL CONDUCTOR ENDS AND COVER THE BOX.

VOLTAGE DROP IN BRANCH CIRCUITS SHALL NOT EXCEED 2%. ALL BRANCH CIRCUITS SHALL HAVE EQUIPMENT GROUNDING CONDUCTOR'S AND SHALL BE SIZED PER NEC TABLE 250-95.

16130 — OUTLET BOXES, JUNCTION BOXES AND WIRING BODIES/GUTTERS

FURNISH AND INSTALL OUTLET BOXES, FLOOR BOXES, PULL BOXES, JUNCTION BOXES AND WIRING GUTTERS AS SHOWN ON THE CONTRACT DOCUMENTS OR AS REQUIRED. 16130.02 - OUTLET/JUNCTION BOXES

PROVIDE WIRING DEVICES, FIXTURES AND SPECIAL SYSTEM DEVICES WITH OUTLET BOX. USE GALVANIZED STEEL BOXES CONFORMING TO UL STANDARD 514A FOR CONCEALED AND EXPOSED DRY LOCATIONS. ALL BOXES SHALL HAVE MATCHING COVER PLATES. USE 1/16" THICK STEEL BOXES AND COVERS OF FORM AND DIMENSION ADAPTED TO ITS SPECIFIC USE AND LOCATION, KIND OF FIXTURE

OR DEVICE TO BE USED AND NUMBER, SIZE AND ARRANGEMENT OF CONNECTION CONDUITS AND NUMBER OF WIRES IN OUTLET, ALL IN ACCORDANCE WITH THE NEC. ALL BOXES SHALL BE SET IN WALLS, COLUMNS, FLOORS, OR CEILINGS SO AS TO BE FLUSH WITH THE FINISHED SURFACE AND BE ACCURATELY SET AND RIGIDLY SECURED IN POSITION. PROVIDE PLASTER RINGS, EXTENSION RINGS AND MASONRY RINGS AS REQUIRED FOR FLUSH MOUNTING.

MANUFACTURER'S: NATIONAL ELECTRICAL, APPLETON, STEEL CITY OR RACO

FURNISH PULL, TAP AND CABLE SUPPORT BOXES REQUIRED BY THE NEC FOR EXCESSIVE NUMBER OF 90 DEGREE CONDUIT BENDS,

BOX CONSTRUCTION PER NEC AND CONFORMING TO UL STANDARD #50. BOX TO BE MANUFACTURED WITH MINIMUM 12 GAUGE

PROVIDE SEPARATE PULL BOX FOR EACH FEEDER.

BOXES LOCATED IN DAMP OR WET LOCATIONS SHALL BE WELDED CONSTRUCTION AND FINISHED WHITE INSIDE AND GRAY OUTSIDE WITH WATERPROOF PAINT. PROVIDE GASKETED DOOR AND CORNERS. PROVIDE RAIN DRIP SHIELDS. BOXES SHALL CARRY NEMA 3R (WEATHERPROOF) OR NEMA 4 (WATERTIGHT) LABELS AS SPECIFIED.

ACCEPTABLE MANUFACTURERS: HOFFMAN, KEYSTONE, BURNS

CONDUIT BODIES SHALL BE INSTALLED TO PROVIDE EASE OF CONDUCTORS AND TO PROVIDE NEAT APPEARANCE TO CONDUIT INSTALLATION, AND AS SHOWN ON THE DRAWINGS. CONDUIT BODIES SHALL BE CONSTRUCTED OF MALLEABLE IRON OR COPPER FREE

ALUMINUM CASTINGS. BODIES SHALL BE FINISHED WITH STANDARD DURABLE EXTERIOR COATINGS OF MANUFACTURER SPECIFIED. PROVIDE ROLLERS IN TYPE "C" AND TYPE "LB" BODIES, 1-1/4" SIZE AND LARGER. PROVIDE GASKETED PLATED STEEL OR MALLEABLE

ACCEPTABLE MANUFACTURERS: CROUSE-HINDS, KILLARK, APPLETON

<u>16130.05 - GUTTERS (WIREWAYS)</u>

8"X8" AND SMALLER — USE STANDARD ASSEMBLE CONSISTING OF CODE GAGE GALVANIZED OR PAINTED STEEL AND COMBINATION HINGED/SCREWED COVERS.

WHERE INDICATED ON THE DRAWINGS, WIRING SHALL BE RUN IN EXPOSED METAL RACEWAYS, COMPLETE WITH OUTLET BOXES AND FITTINGS. ALL CIRCUITS RUN IN SURFACE METAL RACEWAYS SHALL HAVE GROUND CONDUCTOR WITH GREEN INSULATION SIZED PER NEC, BUT NOT SMALLER THAN #12 AWG SCREW CONNECTED TO EACH OUTLET BOX.

ACCEPTABLE MANUFACTURERS - WIREMOLD, PANDUIT

<u>16134 – PANELBOARDS</u>

PROVIDE AND INSTALL LIGHTING AND POWER PANEL BOARDS, RATED FOR 600 VOLTS OR LESS, AS SPECIFIED HEREIN AND AS SHOWN OR INDICATED ON THE DRAWINGS AND SCHEDULES.

PROVIDE SHOP DRAWINGS FOR EACH PANELBOARD. INCLUDE INDIVIDUAL DIAGRAM OF EACH PANELBOARD SHOWING ALL SPECIFIED REQUIREMENTS. IN ADDITION, SUBMITTALS SHALL INDICATE OVERALL PANELBOARD DIMENSIONS, INTERIOR DIMENSIONS, BUS CONFIGURATION, WIRE GUTTER DIMENSIONS, SHORT CIRCUIT RATING PANELBOARD AND OVERCURRENT DEVICES.

CONSTRUCT PANELBOARDS IN ACCORDANCE WITH THE LATEST ADDITION OF THE FOLLOWING STANDARDS: UL STANDARDS NO. 50, 67, 98, 489, AND 493 NEMA PUBLICATION PB-1

PANELBOARD ASSEMBLY SHALL BE UL LABELED, AND LABELED AS SERVICE ENTRANCE EQUIPMENT WHERE USED FOR THAT PURPOSE. 16134.04 - BASIC PANELBOARD CONSTRUCTION

PANELBOARDS TO BE SAME MANUFACTURER AS OTHER DISTRIBUTION EQUIPMENT PANELBOARDS, BUSSING AND OVERCURRENT DEVICE SHALL HAVE INTEGRATED EQUIPMENT FAULT RATING EQUAL TO OR GREATER THAN

BUSSING SHALL BE 98% CONDUCTIVITY COPPER SIZED TO NEC AND NEMA STANDARDS. NEUTRAL BUSSES SHALL BE COPPER AND SIZED FOR 100% ON THE SAME BASIS AS PHASE BUSSING AS DESCRIBED AND INSULATED

PROVIDE 100% CAPACITY CONTINUOUS COPPER GROUND BUS IN EACH PANEL CABINET. GROUND BUSSES SHALL BE BOLTED TO THE

FURNISH PANELBOARDS WITH VOLTAGE, CURRENT, SHORT CIRCUIT RATING, SIZE AND MOUNTING AS INDICATED ON THE DRAWINGS AND SCHEDULES. IF THE DRAWINGS DO NOT STATE THE INTERRUPT RATING IT SHALL BE 100,000AIC.

16134.05 - POWER DISTRIBUTION PANELBOARDS (1200A AND SMALLER) POWER DISTRIBUTION PANELS TO BE SQUARE-D TYPE I-LINE OR APPROVED EQUAL. CIRCUIT BREAKERS SHALL BE BOLT-ON, THERMAL-MAGNETIC TYPE, QUICK-MAKE, QUICK-BREAK, ENCLOSURE COMPENSATED, OF SINGLE CONSTRUCTION, TRIP FREE ON FAULTS, THERMAL-INVERSE TIME DELAY ELEMENT AND MAGNETIC INSTANTANEOUS TRIP COIL IN EACH UNGROUNDED PHASE CONDUCTOR. OR APPROVED (4) FOUR FUNCTION SOLID STATE TRIP UNIT. THE (4) FOUR FUNCTION SOLID STATE TRIP UNIT SHALL INCLUDE LONG TIME DELAY, SHORT TIME DELAY, INSTANTANEOUS AND GROUND FAULT.

AT A MINIMUM GROUND FAULT PROTECTION OF EQUIPMENT SHALL BE PROVIDED FOR SOLIDLY GROUNDED WYE ELECTRICAL SERVICES FOR EACH SERVICE DISCONNECT RATED FOR 1000 AMPERES OR MORE PER NEC 230.

PANEL CABINETS SHALL BE CODE GAUGE GALVANIZED STEEL BOXES WITH TURNED EDGES, REMOVABLE BARRIERS, WIRE GUTTERS ON ALL SIDES AND KNOCKOUTS FOR CONDUIT CONNECTIONS. CABINETS SHALL HAVE ONE PIECE FRONTS AND SHALL HAVE HINGED KEY LOCKING

16134.06 - LIGHTING AND APPLIANCE PANELBOARDS LIGHTING AND APPLIANCE PANELBOARDS SHALL BE SQUARE-D TYPE NOOD OR NEHB OR APPROVED EQUAL. PANELBOARDS SHALL BE DESIGNED AS SHOWN ON THE DRAWINGS. NUMBER AND SIZE OF CIRCUIT BREAKERS IN EACH PANELBOARD SHALL BE AS SCHEDULED

BREAKERS SHALL BE THERMAL MAGNETIC TYPE, QUICK MAKE, QUICK BREAK, ENCLOSURE COMPENSATED, OF SINGLE CONSTRUCTION. TWO OR THREE POLE BREAKERS, WHERE CALLED FOR, SHALL BE SINGLE UNIT COMMON TRIP. BREAKERS SHALL BE BOLT-ON TYPE.

CABINETS SHALL BE CONSTRUCTED OF ONE PIECE CODE GAUGE GALVANIZED STEEL THE MOUNTING STUDS AND KNOCKOUTS FOR CONDUIT CONNECTIONS AS REQUIRED. FRONTS SHALL BE ONE PIECE ON CODE GAUGE FURNITURE STEEL WITH ADJUSTABLE FASTENERS AND RECESSED DOORS FITTED WITH CONCEALED HINGES, FLUSH CATCH AND LOCK. CABINETS SHALL BE SURFACE OR FLUSH MOUNTED AS INDICATED ON THE DRAWINGS. ALL FRONTS AND ALL SURFACE MOUNTED CABINETS SHALL HAVE RUSTPROOF PRIME COAT AND 2

ALL BRANCH CIRCUITS TO PANELBOARDS SHALL BE CONNECTED IN A MANNER SO THAT LOADS ARE BALANCED OVER EACH PHASE AS EQUALLY AS POSSIBLE. THE BACK DOOR SHALL BE FITTED WITH A GLASS OR PLASTIC COVERED TYPEWRITTEN SCHEDULE IDENTIFYING

BREAKERS USED AS SWITCHES FOR 120 OR 277 VOLT CIRCUITS SHALL BE APPROVED FOR THE PURPOSE AND AND MARKED "SWB". BREAKERS USED FOR PROTECTION OF HVAC EQUIPMENT SHALL BE HACR TYPE

16134-.07 - IDENTIFICATION PERMANENTLY ATTACH NAMEPLATES AND CIRCUIT NUMBERS TO EACH PANEL

PROVIDE EACH PANELBOARD WITH NAMEPLATE SHOWING PANEL DESIGNATION, VOLTAGE RATING AND PHASE

LABEL SHALL BE ENGRAVED LAMINATED-PLASTIC NAMEPLATE. NAMEPLATES SHALL BE BLACK WITH 1/4" HIGH WHITE LETTERS UNLESS

16134.08 - ACCEPTABLE MANUFACTURERS CUTI FR-HAMMF

16134 09 - INSTALLATION MOUNT PANELBOARDS SECURELY TO BUILDING STRUCTURE WITH 3/8" MINIMUM DIAMETER GALVANIZED BOLTS AND INSERTS NUMBERED AS REQUIRED FOR THE SIZE OF THE PANEL, BUT NOT LESS THAN 4. MOUNT PANELBOARDS WITH CENTERLINE 4'-6" APPROXIMATELY ABOVE FINISHED FLOOR WITH THE TOP A MAXIMUM OF 74" AFF. WHERE PANELS OF DIFFERENT HEIGHTS ARE MOUNTED ADJACENT,

INSTALL THE TOP PANEL TRIM AT THE SAME HEIGHT ABOVE THE FLOOR. CLOSE ALL UNUSED OPENINGS MOUNT FEEDER PANELBOARDS TALLER THAN 66" ON 4" HIGH 2500# CONCRETE PAD AND BOLT TO THE WALL AND THE PAD WITH 1/2" DIAMETER BOLTS AND INSERTS.

16140- SWITCHES AND RECEPTACLES

GENERAL ELECTRIC

16140.01 - DESCRIPTION OF WORK WIRING DEVICES, PLATES AND INSTALLATION.

FURNISH AND INSTALL DEVICES AND ASSOCIATED DEVICE PLATES AS SHOWN ON THE DRAWINGS. ALL OUTLETS AND SWITCHES SHALL BE OF THE SAME MANUFACTURER. COLORS OF SWITCHES AND RECEPTACLES SHALL BE AS REQUESTED BY THE ARCHITECT

STANDARD RECEPTACLES, UNLESS OTHERWISE NOTED, SHALL BE 3 WIRE GROUNDED TYPE, NEMA CONFIGURATION 5-20R, DUPLEX RECEPTACLE RATED AT 20 AMPS AT 125VAC. RECEPTACLES TO COMPLY WITH UL STANDARD 498 AND FEDERAL SPECIFICATION

GROUND-FAULT INTERRUPTER (GFCI) RECEPTACLES: UL STANDARD 943, "GROUND FAULT INTERRUPTERS," FEED-THROUGH TYPE, WITH INTEGRAL NEMA 5-20R DUPLEX RECEPTACLE. ARRANGE THE GFCI RECEPTACLE TO PROTECT CONNECTED DOWNSTREAM RECEPTACLES ON THE SAME CIRCUIT AS SHOWN OR AS REQUIRED. PENDENT CORD/CONNECTOR DEVICES: MATCHING, LOCKING TYPE, PLUG AND RECEPTACLE BODY CONNECTOR, NEMA L5-20P AND

L5-20R, HEAVY DUTY GRADE UNLESS OTHERWISE SPECIFIED. CORD AND PLUG SETS: MATCH VOLTAGE AND CURRENT RATINGS AND THE NUMBER OF CONDUCTORS TO THE REQUIREMENTS OF THE EQUIPMENT BEING CONNECTED. THE CORD SHALL BE RUBBER INSULATED, STRANDED COPPER CONDUCTORS, WITH TYPE SOW-A JACKET. SWITCHES: QUIET TYPE A.C. SWITCHES, LISTED AND LABELED TO COMPLYING WITH UL STANDARD 20 "GENERAL USE SNAP SWITCHES",

WHERE INDICATED ON THE PLANS PROVIDE PILOT LIGHT WITH THE ABOVE SNAP SWITCHES. PILOT LIGHT SHALL AND SWITCH TO BE INSTALLED IN A TWO GANG PLATE WITH FLUSH NEON PILOT LIGHT FOR 125 OR 227 VOLT OPERATION AS APPLICABLE, WITH A RED

AND FEDERAL SPECIFICATION W-S-896. MANUFACTURERS AS NOTED IN ELECTRICAL DEVICE SCHEDULE.

16140.03 - ACCEPTABLE MANUFACTURERS

PASS AND SEYMOUR/LEGRAND BRYANT EAGLE

FURNISH AND INSTALL ALL DEVICE COVER PLATES, 0.1" THICK SMOOTH PLASTIC COVER PLATES. VERIFY COLOR AND MATERIAL WITH THE ARCHITECT BEFORE INSTALLATION. SWITCH PLATES IN UNFINISHED ROOMS SHALL BE STAMPED STEEL PLATES, CADMIUM PLATED. DEVICE PLATE SHALL BE MANUFACTURED BY THE DEVICE MANUFACTURER WHERE APPLICABLE.

FURNISH WEATHER PROOF DEVICES WITH INDIVIDUAL GASKETED ALUMINUM OR STAINLESS STEEL COVERS.

16140.05 - MULTI-OUTLET ASSEMBLIES COMPLY WITH STANDARD UL-5 "SURFACE METAL RACEWAYS AND FITTINGS".

COMPONENTS OF ASSEMBLIES: PRODUCTS OF A SINGLE MANUFACTURER DESIGNED TO BE USED TOGETHER TO PROVIDE A COMPLETE MATCHING ASSEMBLY OF RACEWAYS AND RECEPTACLES.

RACEWAY MATERIAL: METAL WITH MANUFACTURERS STANDARD CORROSION RESISTANT FINISH.

WIRE: NO. 12 AWG MINIMUM ACCEPTABLE MANUFACTURER

WIREMOLD G-3000 SERIES FQUAL BY ISODUCT EQUAL BY HUBBELL

16140.06 - INSTALLATION INSTALL DEVICES VERTICAL 48" AFF FOR SWITCHES AND 18" AFF FOR RECEPTACLES UNLESS OTHERWISE SHOWN. DEVICES SHALL BE INSTALLED PLUMB AND SECURE ON ALL SIDES. INSTALL RECEPTACLES WITH GROUND SLOT DOWN.

16170- DISCONNECTS (MOTOR, CIRCUIT, AND SEPARATE CIRCUIT BREAKERS)

FURNISH AND INSTALL SAFETY SWITCHES, DISCONNECTS AND SEPARATELY MOUNTED ENCLOSED CIRCUIT BREAKERS RATED TO 1200 AMPERES, 600 VOLTS AS SHOWN ON THE DRAWINGS AND SPECIFIED HEREIN.

16170.02 - STANDARDS

NEMA STANDARD KS1-1983 FOR ENCLOSED SWITCHES NEMA AB1-1996 FOR MOLD CASE CIRCUIT BREAKERS AND SWITCHES

DISCONNECT SMITCHES SHALL BE HEAVY DUTY, RATED FOR 250 OR 600 VOLTS AS REQUIRED. SMITCHES SHALL BE QUICK—MAKE, QUICK—BREAK OPERATION AND HORSEPOWER RATED. THE OPERATING HANDLE SHALL BE INTERLOCKED WITH THE SMITCH DOOR TO PREVENT OPENING OF THE DOOR WITH THE SMITCH CLOSED. PROVIDE MECHANICAL OVERRIDE FOR AUTHORIZED PERSONNEL TO OPEN

SWITCHES SHALL BE FUSIBLE OR NON-FUSIBLE AS SHOWN. FURNISH ONE TIME, DUAL ELEMENT, CLASS K5, REJECTION TYPE FUSES FOR

FUSIBLE SWITCHES LARGER THAN 600 AMPS SHALL BE SUITABLE FOR CLASS L FUSES. FUSES SERVING PREDOMINANTLY MOTOR OR RANSFORMER LOADS SHALL BE DUAL ELEMENT, TIME DELAY TYPE, OTHERWISE NON-TIME DELAY FAST ACTING TYPE IS REQUIRED. FUSES SHALL BE CURRENT LIMITING WITH 200,000AIC.

FURNISH SOLID NEUTRAL FOR EACH SWITCH BEING INSTALLED IN A CIRCUIT WHICH INCLUDES A NEUTRAL CONDUCTOR. FURNISH A GROUNDING PAD FOR CONNECTION OF CIRCUIT GROUND WIRES. PROVIDE MECHANICAL LUGS AND POWER DISTRIBUTION CONNECTORS FOR NUMBER, SIZE, AND MATERIAL OF CONDUCTORS AS INDICATED

ACCEPTABLE FUSE MANUFACTURERS

CHASE SHAWMUT

THE DISCONNECT SWITCH SHALL BE FURNISHED WITH PROVISIONS FOR LOCKING WITH A PADLOCK. ENCLOSURES FOR SWITCHES TO BE NEMA 1, GENERAL PURPOSE INDOOR, OR NEMA 3R OR 4 FOR OUTDOOR LOCATIONS, WATERTIGHT.

ACCEPTABLE SWITCH MANUFACTURERS SQUARE-D

CUTLER HAMMER/WESTINGHOUS

16170.04 - SEPARATELY MOUNTED CIRCUIT BREAKERS FURNISH AND INSTALL SEPARATELY MOUNTED CIRCUIT BREAKERS FOR OVERCURRENT PROTECTION OF FEEDERS AND BRANCH CIRCUITS

CIRCUIT BREAKERS SHALL BE THERMAL-MAGNETIC, MOLDED CASE TYPE, RATED FOR 600 VOLTS. THE INTERRUPT RATING SHALL BE AS SHOWN OR ON THE DRAWINGS. IF NO INTERRUPT RATINGS ARE SHOWN ON THE DRAWINGS THEY SHALL BE RATED FOR 100,000AIC. ENCLOSURES FOR INDIVIDUAL CIRCUIT BREAKERS TO BE NEMA 1, GENERAL PURPOSE INDOOR, OR NEMA 3R OR 4 FOR OUTDOOR LOCATIONS, WATERTIGHT.

ACCEPTABLE CIRCUIT BREAKER MANUFACTURERS

GENERAL ELECTRIC CUTLER HAMMER/WESTINGHOUSE

<u> 16450- Grounding</u> 16450.01 - DESCRIPTION OF WORK THIS SECTION INCLUDES GROUNDING OF ELECTRICAL SYSTEMS AND EQUIPMENT AND BASIC REQUIREMENTS FOR GROUNDING FOR PROTECTION OF LIFE, EQUIPMENT, CIRCUITS, AND SYSTEMS.

NFPA 70. ARTICLE 250 - GROUNDING

ALL PRODUCTS SHALL BE UL LISTED AND LABELED.

IEEE STANDARD 142 (GREEN BOOK) 16450.03 - ELECTRICAL SYSTEM AND EQUIPMENT GROUNDING

BOND THE GROUND MAIN SERVICE NEUTRAL, CABINETS, EQUIPMENT, CONDUITS, ETC., PER LATEST EDITION OF THE NEC AND AS SHOWN ON THE DRAWINGS, AND SPECIFIED HEREIN.

GROUND CONDUCTORS SHALL BE 98% CONDUCTIVITY COPPER. OTHER CONDUCTOR REQUIREMENTS SHALL BE THE SAME AS DESCRIBED FOR LOW VOLTAGE, 600 VOLT, CONDUCTORS AND SPECIFIED HEREIN. ALL CONDUIT SYSTEMS, BOXES, ELECTRICAL EQUIPMENT, ENCLOSURES, MOTOR FRAMES, ETC., SHALL BE GROUNDED IN ACCORDANCE WITH

THE REQUIREMENTS OF THE NEC, LOCAL AUTHORITIES AND AS SPECIFIED. A SEPARATE EQUIPMENT GROUND CONDUCTOR SHALL BE INSTALLED INSIDE OF EACH CONDUIT RUN FOR GROUNDING ALL CIRCUITS

ABOVE 48 VOLTS. THE METALLIC CONDUIT SHALL NOT BE USED AS A GROUNDING CONDUCTOR. GROUND WIRE SIZE THRU #10 SHALL BE STRANDED COPPER, GREEN TYPE THHN 75 DEGREES C INSULATION. GROUND WIRES SIZED #8 AND LARGER SHALL BE STRANDED COPPER, TYPE TWHN OR THW WITH GREEN INSULATION OR GREEN TRACER.

GROUNDING CONDUCTORS IN CONTACT WITH EARTH SHALL BE SOLID BARE TINNED COPPER.

NO ELECTRICAL SYSTEM NEUTRAL SHALL BE USED AS A EQUIPMENT GROUND.

GROUND WIRES SHALL BE RAN CONTINUOUS FROM TERMINATION POINT TO TERMINATION POINT WITHOUT SPLICES. ALL OUTLET BOXES AND JUNCTION BOXES, DISCONNECTS, ETC., SHALL BE GROUNDED. THE GROUND WIRE TERMINAL OF EACH DEVICE SHALL BE CONNECTED TO THE GROUND CONDUCTOR.

ALL METAL ENCLOSURES FOR ELECTRICAL DISTRIBUTION AND CONTROLS, ALL METAL EQUIPMENT SUPPORTS FOR ELECTRICAL CONTROLS

AND ALL SIMILAR ITEMS SHALL BE CONNECTED TO THE GROUND SYSTEM. FLEXIBLE CONDUIT SHALL BE BONDED AND GROUNDED IN ACCORDANCE WITH THE NEC. ALL FLEXIBLE CONDUITS WITH CIRCUITS CONTAINING AN AMPACITY GREATER THAN 20 AMPS SHALL INCLUDE A GROUND WIRE AS WELL AS ANY FLEXIBLE CONDUIT OVER 6 FEET IN LENGTH.

16500- LUMINAIRES 16500.01 - DESCRIPTION OF WORK THIS SECTION SPECIFIES MATERIALS USED FOR LIGHTING LUMINAIRES, THEIR INSTALLATION AND LAMPING. SPECIFIC LUMINARE TYPES ARE SPECIFIED BY CATALOG NUMBER IN THE LUMINARE (LIGHTING) SCHEDULE ON THE DRAWINGS.

16500.02 - STANDARDS CMB - CERTIFIED BALLAST MANUFACTURERS

ETL — ELECTRICAL TESTING LABORATORY IES — ILLUMINATING ENGINEERING SOCIETY

FURNISH LUMINARIES AS SHOWN ON THE DRAWINGS IN THE LUMINARE (LIGHTING) SCHEDULE. THIS SHALL INCLUDE ALL LAMPS, MATERIAL AND LABOR TO SECURELY HANG FIXTURES, CLEAN THEM AND MAKE THEM COMPLETE AND READY FOR USE. ALL FIXTURES SHALL INCLUDE ALL NECESSARY ACCESSORIES REQUIRED.

VERIFY EXACT TYPE CEILING AND RECESSING DEPTH OF RECESSED LUMINARIES AND FURNISH SPECIFIC MOUNTING TRIMS AND

VERIFY PROPER VOLTAGE FOR EACH LUMINARE AND PROVIDE BALLAST'S TO MATCH ACTUAL APPLIED VOLTAGE AS SHOWN ON DRAWINGS.



Contract Date Rev No. / 2 Rev No. / 3 Rev No. 24 Rev No. 25 Rev No. / 6 Project Number: DWG File Designed By: JAW Drawn By: plan4 Approved By: 03/25/202

